



CONSTRUCTION PLANS FOR:  
**7TH STREET BEACH  
 RESTROOM  
 FEMA REPAIRS**

PREPARED FOR:  
**CITY OF MEXICO BEACH  
 BAY COUNTY, FLORIDA**

CITY OF MEXICO BEACH COUNCIL MEMBERS:

- MAYOR AL CATHEY, GROUP 1
- JERRY SMITH, GROUP 2
- BOBBY POLLOCK, GROUP 3
- ADRIAN WELLE, GROUP 4
- RICHARD WOLFF, GROUP 5

PREPARED BY:



PROJECT NUMBER - 50112879  
 OCTOBER, 2022




48 HOURS  
 BEFORE YOU DIG  
 CALL SUNSHINE ONE  
 1-800-432-4770  
 www.callsunshine.com

**BID SET**

REV. NO.	DATE	REVISION DESCRIPTION	RELEASED TO	RELEASE DATE

**VICINITY MAP**

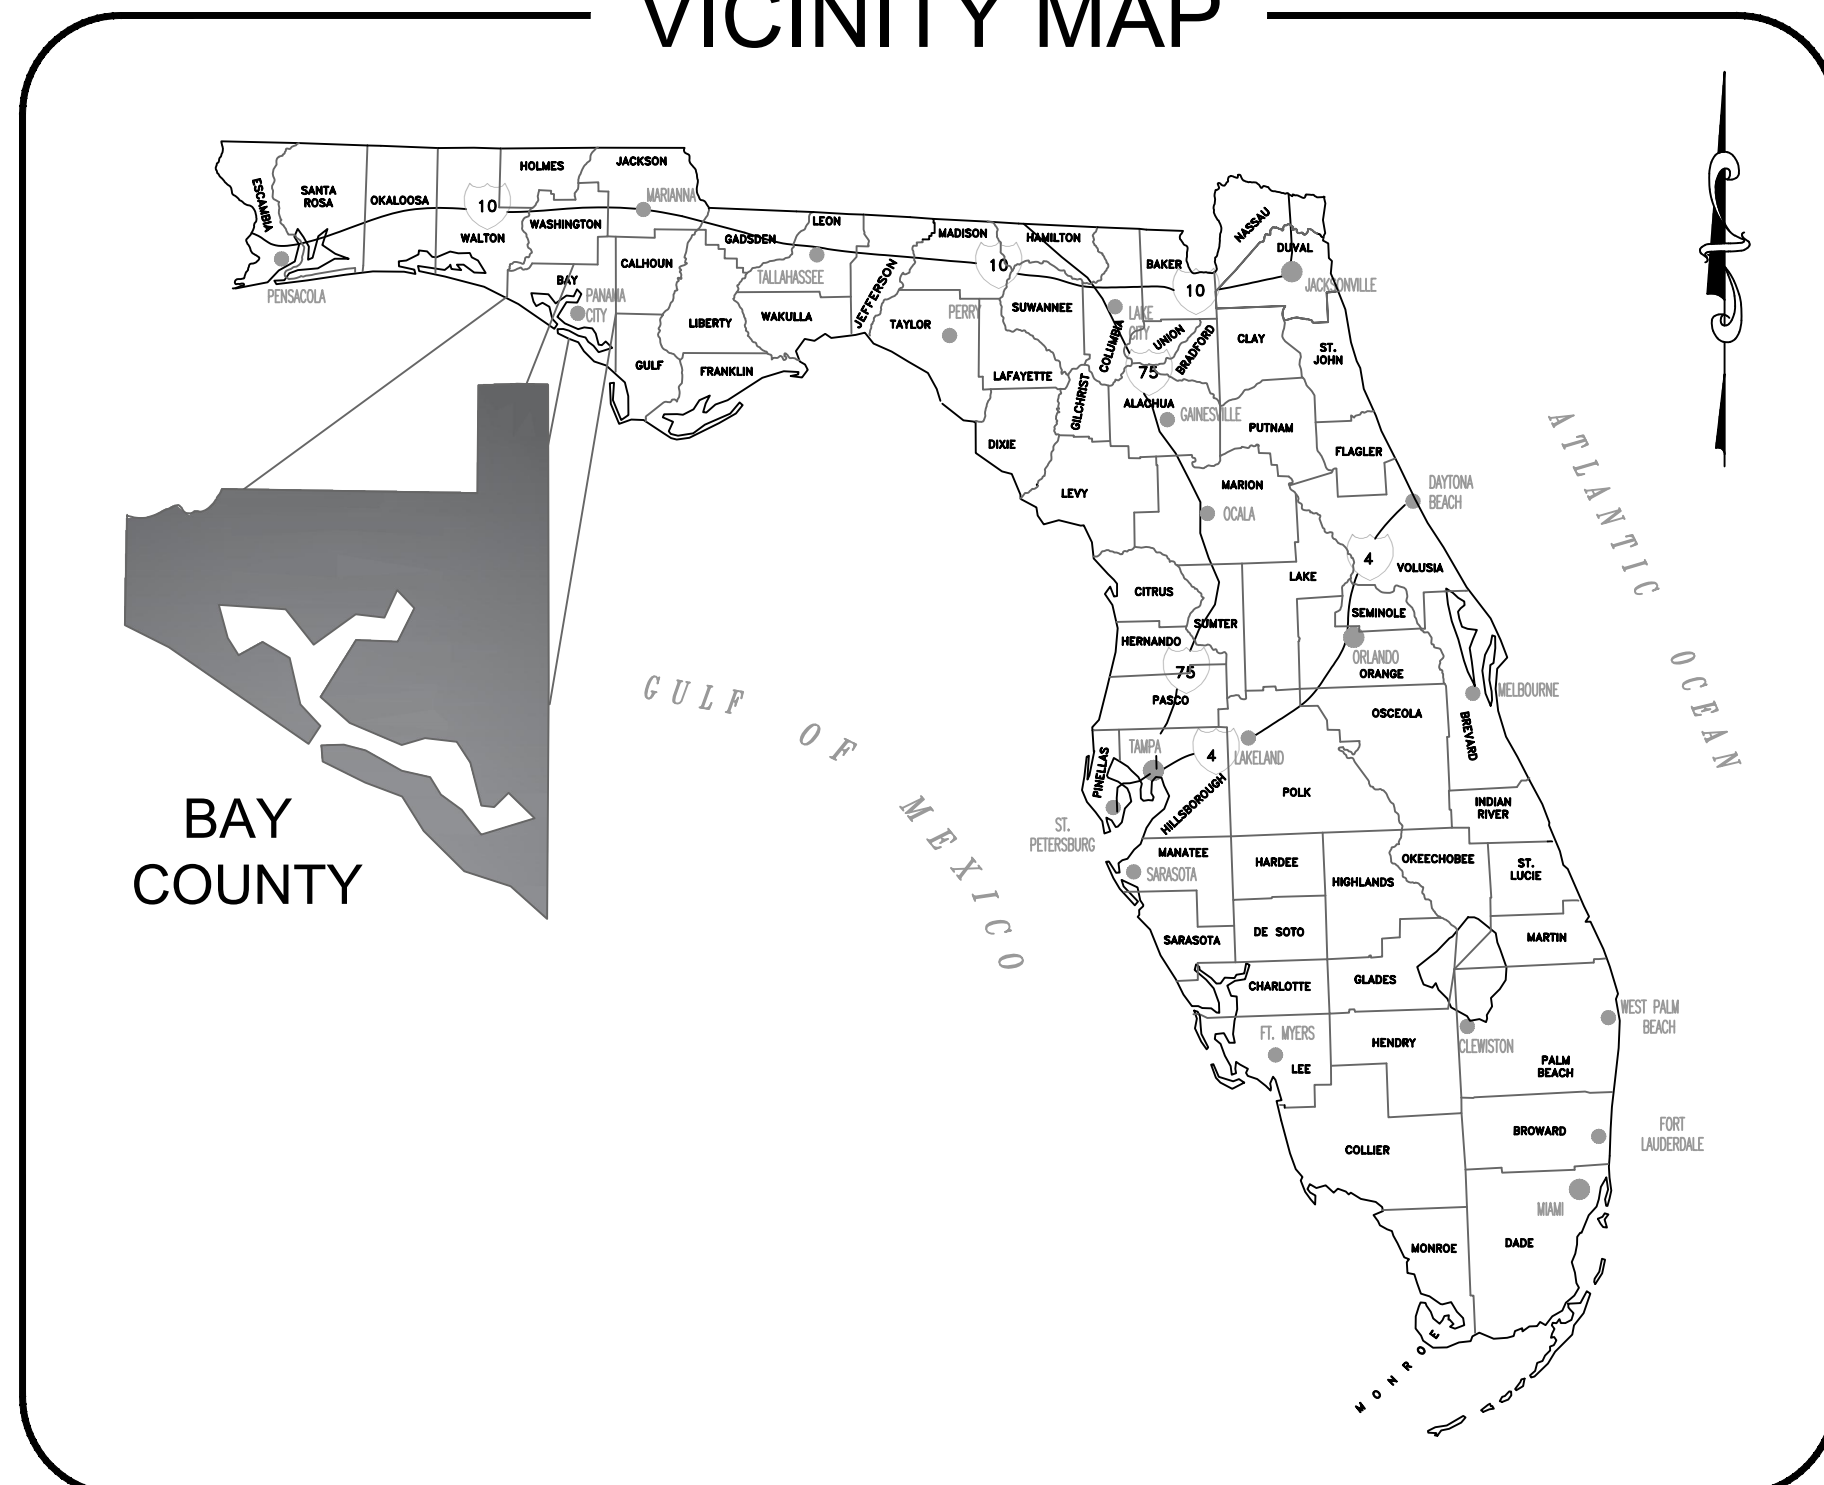

**DRAWING INDEX**

<u>CIVIL-S.C.E.</u>	
DWG No.	TITLE
CVR	COVER SHEET
G-1	GENERAL NOTES
C-1	SITE PLAN
C-2	SITE PLAN & PROFILE
C-3	GRADING PLAN
C-4	PLANTING PLAN
<u>CIVIL-DEWBERRY</u>	
DWG No.	TITLE
U-1	UTILITY PLAN
<u>BY OTHERS</u>	
DWG No.	TITLE
A100-A105	ARCHITECTURAL DRAWINGS
E-1	ELECTRICAL DRAWING
M-1	MECHANICAL DRAWING
P-1	PLUMBING DRAWING
S1-S3	STRUCTURAL DRAWINGS



**SOUTHEASTERN  
CONSULTING ENGINEERS, INC.**

# F.D.E.P. BEACHES & COASTAL SYSTEMS PERMIT DRAWINGS


SECTION	25	TOWNSHIP	6S	RANGE	12W
---------	----	----------	----	-------	-----

MEXICO BEACH, FL 32410  
BAY COUNTY PARCEL NO.: 04189-000-000


FOR

## CITY OF MEXICO BEACH

### PROJECT VICINITY

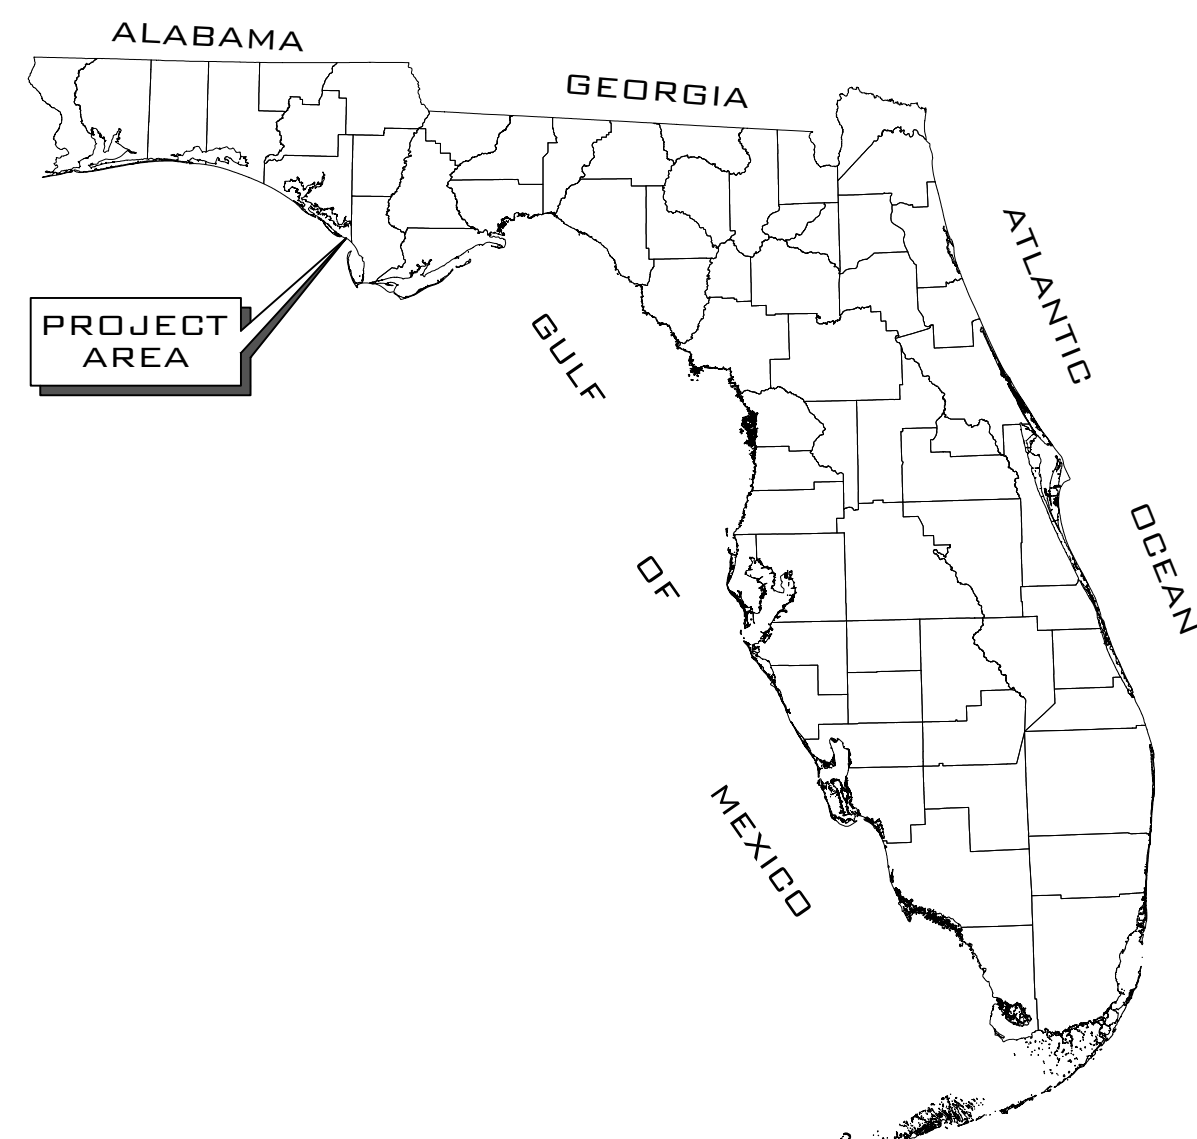

### LOCATION MAP

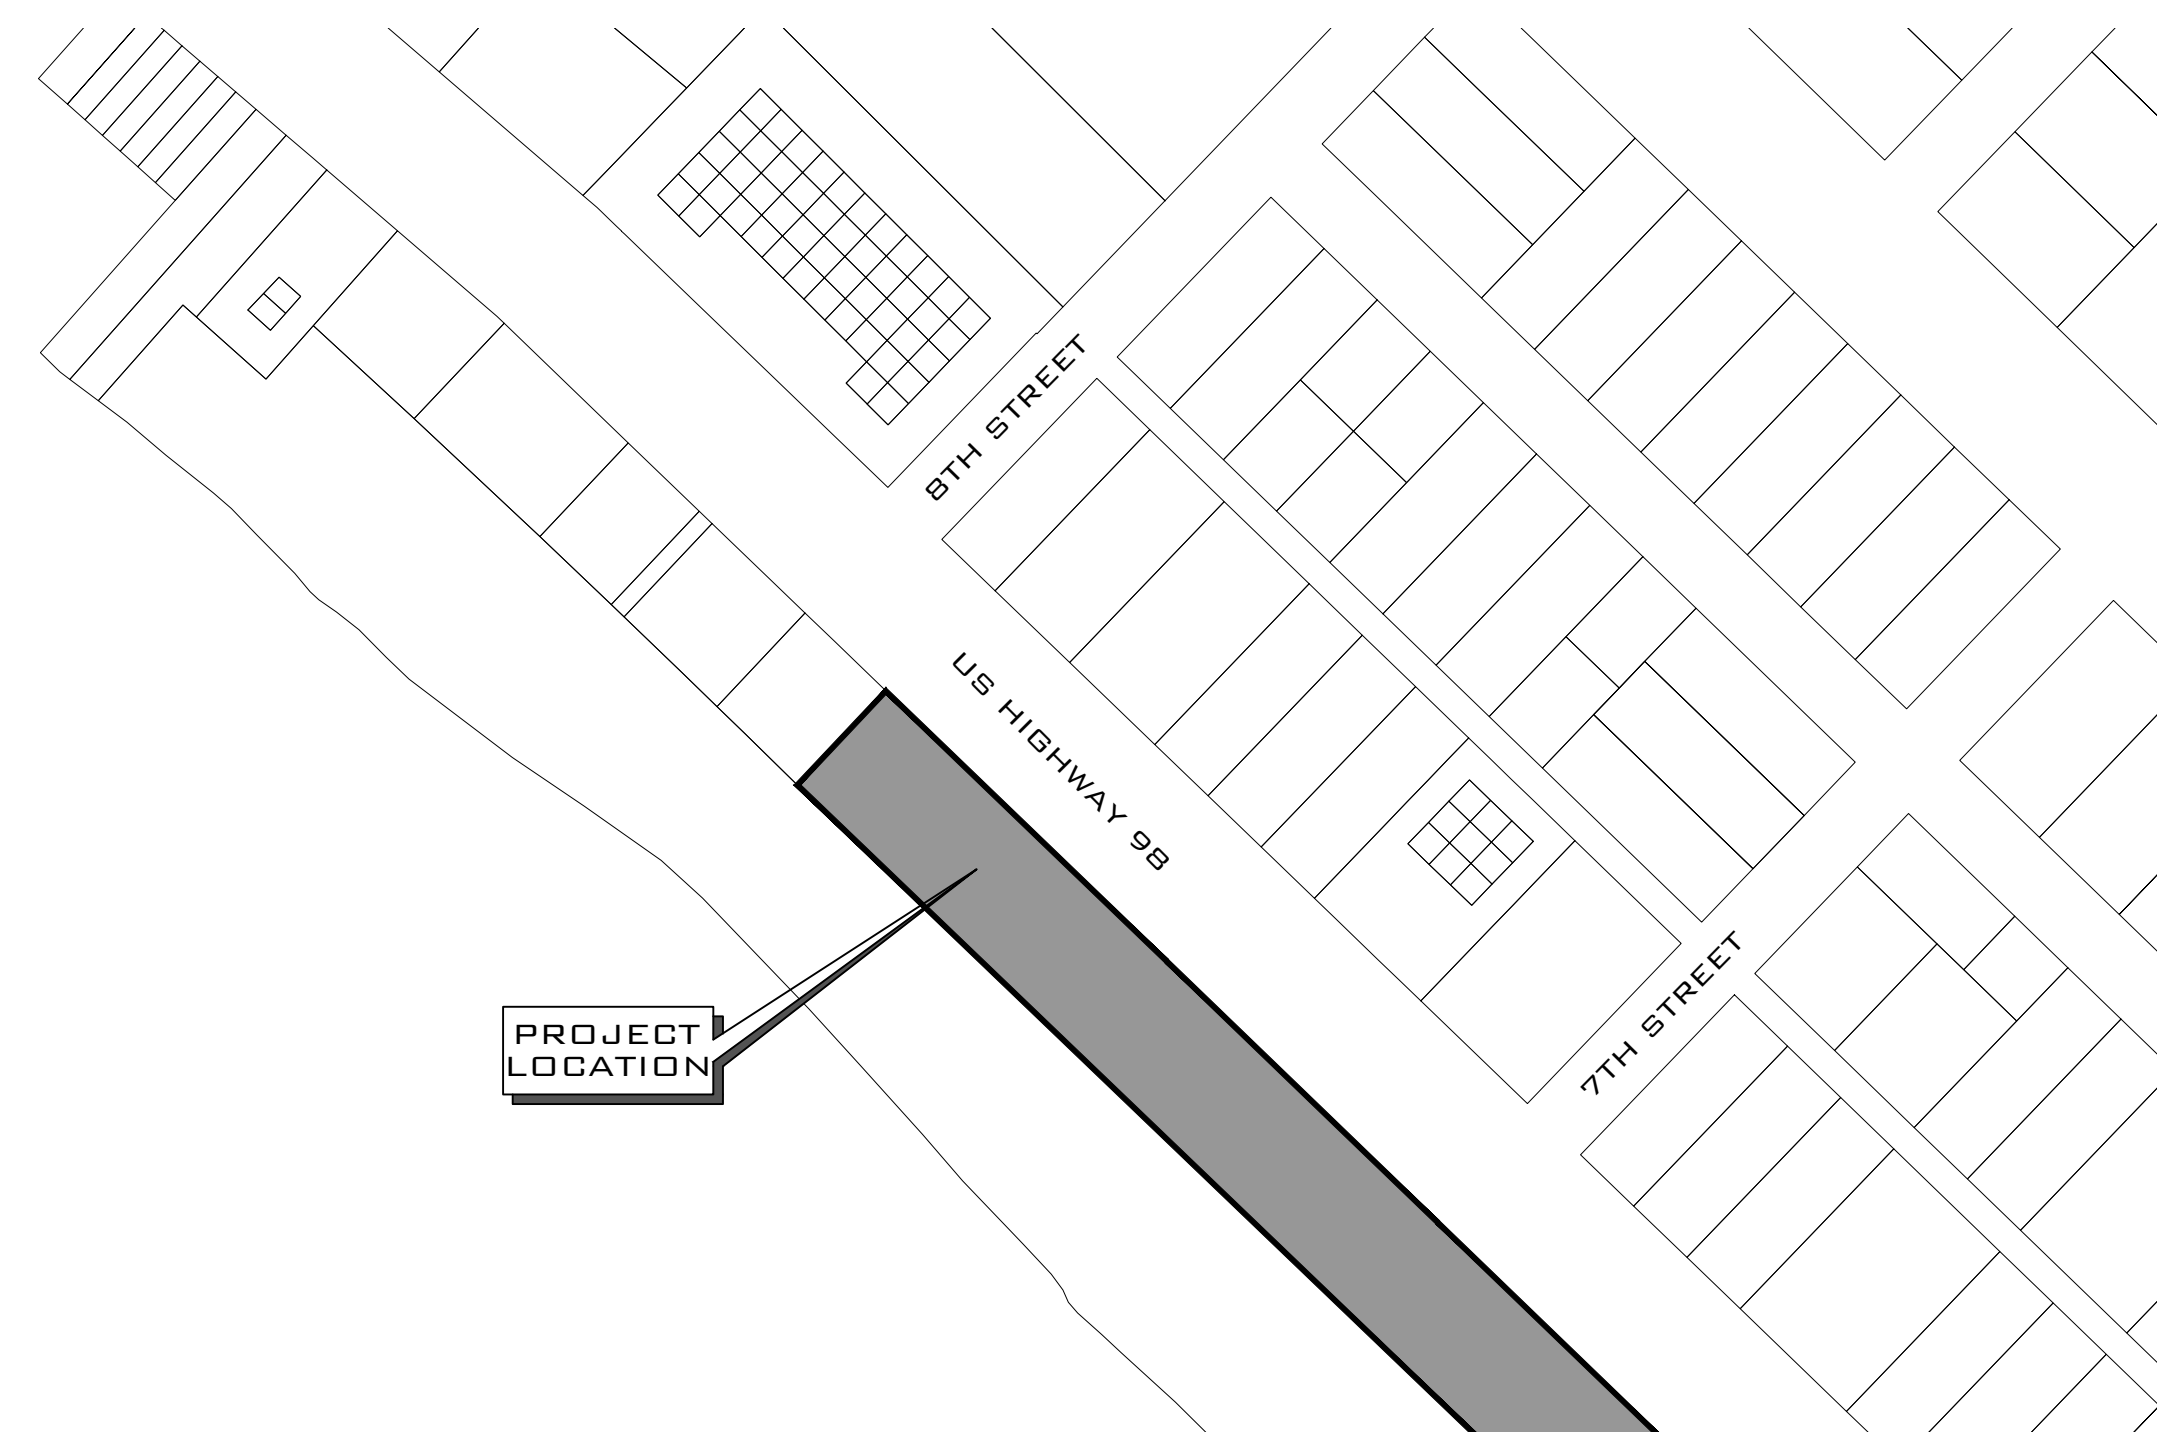

### SHEET INDEX

SHEET	SHEET NAME
CVR	COVER SHEET
G1	GENERAL NOTES
C1	SITE PLAN
C2	SITE PLAN & PROFILE
C3	GRADING PLAN
C4	PLANTING PLAN

**NOTE:**

- ALL SCALES HEREIN SHALL BE CONSIDERED APPROPRIATE FOR 24X36 SIZE PLOTS ONLY.
- DUE TO REPRODUCTION, THE SCALES SHOWN ON THIS PLAN SET MAY HAVE BEEN COMPROMISED.



**SOUTHEASTERN  
CONSULTING ENGINEERS, INC.**  
P.O. BOX 141  
MEXICO BEACH, FL 32456  
(850) 639-3860 (850) 227-1297  
LB# 25064

### COVER SHEET

7TH STREET BEACH RESTROOM BUILDING  
HWY 9B  
MEXICO BEACH, FLORIDA 32410

PROJECT NUMBER: 21-167-14

DESIGNED BY:	DRAWN BY:	CHECKED BY:	DATE:	BY:	ITEM:
H.B.	H.B.	J. HUSBAND			

FOR: CITY OF MEXICO BEACH  
201 PARADISE PATH  
MEXICO BEACH, FL 32456  
DATE: 3/16/22  
SHEET NO.

**CVR**

**GENERAL NOTES**

- THE CONTRACTOR SHALL VERIFY ALL EXISTING CONDITIONS AND DIMENSIONS AT THE JOB SITE TO INSURE THAT ALL NEW WORK WILL FIT IN THE MANNER INTENDED ON THE PLANS. SHOULD ANY CONDITIONS EXIST THAT ARE CONTRARY TO THOSE SHOWN ON THE PLANS, THE CONTRACTOR SHALL NOTIFY THE ENGINEER AND THE CITY OF MEXICO BEACH, FLORIDA OF SUCH DIFFERENCES IMMEDIATELY AND PRIOR TO PROCEEDING WITH THE WORK.
- THE CONTRACTOR SHALL COMPLY WITH ALL ORDINANCES SET FORTH BY THE NORTHWEST FLORIDA WATER MANAGEMENT DISTRICT AND FLORIDA DEPARTMENT OF ENVIRONMENTAL PROTECTION.
- THE CONTRACTOR SHALL MAINTAIN THE CONSTRUCTION SITE IN A SECURE MANNER. ALL OPEN TRENCHES AND EXCAVATED AREAS SHALL BE PROTECTED FROM ACCESS BY THE GENERAL PUBLIC.
- ANY PUBLIC LAND CORNER WITHIN THE LIMITS OF CONSTRUCTION SHALL BE PROTECTED. IF A CORNER MONUMENT IS IN DANGER OF BEING DESTROYED AND HAS NOT BEEN PROPERLY REFERENCED, THE CONTRACTOR SHOULD NOTIFY THE ENGINEER.
- THE CONTRACTOR SHALL IMPLEMENT ALL COMPONENTS OF THE EROSION AND SEDIMENTATION CONTROL PLAN PRIOR TO ANY EARTH DISTURBING ACTIVITIES. ALL COMPONENTS SHALL BE MAINTAINED BY THE CONTRACTOR UNTIL ALL VEGETATION IS ESTABLISHED, THE ENTIRE PROJECT AREA IS STABILIZED AND THE OWNER HAS ACCEPTED OPERATION AND MAINTENANCE.
- ALL DISTURBED AREAS NOT SODDED SHALL BE SEEDED WITH A MIXTURE OF LONG-TERM VEGETATION AND QUICK GROWING SHORT-TERM VEGETATION FOR THE FOLLOWING CONDITIONS. FOR THE MONTHS FROM SEPTEMBER THROUGH MARCH, THE MIX SHALL CONSIST OF 70 POUNDS PER ACRE OF LONG-TERM SEED AND 20 POUNDS PER ACRE OF WINTER RYE. FOR THE MONTHS OF APRIL THROUGH AUGUST, THE MIX SHALL CONSIST OF 70 PER ACRE OF LONG-TERM SEED AND 20 POUNDS PER ACRE OF MILLET.
- THE LOCATION OF THE UTILITIES SHOWN IN THE PLANS ARE APPROXIMATE ONLY. THE EXACT LOCATION SHALL BE DETERMINED BY THE CONTRACTOR DURING CONSTRUCTION. CONTRACTOR SHALL PROTECT ALL UTILITIES WITHIN THE PROJECT AREAS.
- ALL UTILITY CONSTRUCTION SHALL MEET THE WATER AND WASTEWATER UTILITY STANDARDS OF THE UTILITY SERVICE PROVIDER IN THE PROJECT AREA.
- THE CONTRACTOR SHALL WASTE ALL EXCESS EARTH ON SITE AS DIRECTED BY THE ENGINEER.
- ALL SITE CONSTRUCTION SHALL BE IN ACCORDANCE WITH THE LOCAL GOVERNING BODY'S LAND DEVELOPMENT REGULATIONS.
- CONTRACTOR SHALL REVIEW AND BECOME FAMILIAR WITH ALL REQUIRED UTILITY CONNECTIONS PRIOR TO BIDDING. CONTRACTOR SHALL PROVIDE ALL WORK AND MATERIALS REQUIRED TO COMPLETE CONNECTION TO THE EXISTING UTILITIES. THIS INCLUDES BUT IS NOT LIMITED TO MANHOLE CORINGS, WET TAPS, PAVEMENT REPAIRS AND DIRECTIONAL BORING.
- CONTRACTOR SHALL COORDINATE ALL WORK WITH OTHER CONTRACTORS WITHIN PROJECT AREA.
- CONTRACTOR SHALL PROVIDE ACTUAL INVERT ELEVATIONS ON ALL DRAINAGE STRUCTURES, INCLUDING CULVERTS. PRIOR TO PLACING ANY BASE MATERIAL, DEVIATIONS FROM THE PLANS SHALL BE APPROVED BY THE ENGINEER BEFORE CONTINUING WORK.
- THIS PROJECT IS TO BE CONSTRUCTED IN ACCORDANCE WITH THE F.D.O.T. STANDARD SPECIFICATIONS FOR ROAD AND BRIDGE CONSTRUCTION (CURRENT EDITION) AND THE F.D.O.T. DESIGN STANDARDS (CURRENT EDITION), AWWA SPECIFICATIONS, AND THE LOCAL GOVERNING BODY'S DEVELOPMENT STANDARDS UNLESS OTHERWISE NOTED.
- IF UNSUITABLE MATERIAL IS ENCOUNTERED DURING GRADING, CONTRACTOR SHALL REMOVE UNSUITABLE MATERIAL TO A DEPTH OF 24" BELOW FINISHED GRADE WITHIN THE CONSTRUCTION LIMITS.
- THE CONTRACTOR SHALL NOTIFY THE LOCAL GOVERNING BODY AT LEAST 48 HOURS IN ADVANCE PRIOR TO BEGINNING OF CONSTRUCTION.
- THE CONTRACTOR SHALL BE RESPONSIBLE FOR THE CONSTRUCTION COMMENCEMENT NOTICE AND NOTIFYING THE ENGINEER OF THE CONSTRUCTION SCHEDULE.
- SCE SHALL NOT BE RESPONSIBLE FOR ANY REQUIREMENTS SET FORTH BY THE ELECTRICAL UTILITY PROVIDER CONCERNING METER PLACEMENT OR ANY STRUCTURE RELATED TO THE METER READING/MAINTENANCE.
- IT IS THE SOLE RESPONSIBILITY OF THE OWNER/CONTRACTOR TO MEET ALL LOCAL, STATE, FEDERAL ELECTRICAL PROVIDER REQUIREMENTS CONCERNING THE ELECTRIC METER AND ANY RELATED STRUCTURE IN CONNECTION WITH THE ELECTRICAL METER.



**EROSION CONTROL NOTES**

- THIS EROSION AND SEDIMENTATION CONTROL PLAN COMPLIES WITH THE REQUIREMENTS OF THE FLORIDA DEVELOPMENT MANUAL AND THE FLORIDA EROSION AND SEDIMENT CONTROL INSPECTOR'S MANUAL.
- THE CONTRACTOR SHALL ADHERE TO THE LOCAL GOVERNING BODY, F.D.E.P. AND OTHER GOVERNING AUTHORITIES FOR EROSION AND SEDIMENT CONTROL REGULATIONS. IF THE CONTRACTOR NEEDS TO CHANGE THIS PLAN TO MORE EFFECTIVELY CONTROL EROSION AND SEDIMENTATION, THE CONTRACTOR SHALL USE BMPs FROM THE FLORIDA EROSION AND SEDIMENT CONTROL INSPECTOR'S MANUAL.
- THE CONTRACTOR SHALL ADJUST AND REVISE THIS PLAN TO MEET ACTUAL FIELD CONDITIONS. ANY REVISIONS SHALL BE APPROVED BY THE REVIEWING AGENCIES.
- SEDIMENT AND EROSION CONTROL FACILITIES, STORM DRAINAGE FACILITIES AND DETENTION BASINS SHALL BE INSTALLED PRIOR TO ANY OTHER CONSTRUCTION.
- EROSION CONTROL MEASURES SHALL BE INSPECTED WEEKLY AND AFTER EACH RAINFALL AND REPLACED AS NECESSARY.
- SEDIMENT AND EROSION CONTROL MEASURES SHALL NOT BE REMOVED UNTIL ALL CONSTRUCTION IS COMPLETE AND UNTIL A PERMANENT GROUND COVER HAS BEEN ESTABLISHED.
- ALL OPEN DRAINAGE SWALES SHALL BE GRASSED AND RIPRAP SHALL BE PLACED AS REQUIRED TO CONTROL EROSION.
- SILT FENCES SHALL BE LOCATED ON SITE TO PREVENT SEDIMENT AND EROSION FROM LEAVING PROJECT LIMITS.
- CONTRACTOR SHALL PLACE A DOUBLE ROW OF SILT FENCE IN AREAS WHERE RUNOFF FROM DISTURBED AREAS MAY ENTER WETLANDS.
- DURING CONSTRUCTION AND AFTER CONSTRUCTION IS COMPLETE, ALL STRUCTURES SHALL BE CLEANED OF ALL DEBRIS AND EXCESS SEDIMENT.
- ALL GRADED AREAS SHALL BE STABILIZED IMMEDIATELY WITH A TEMPORARY FAST-GROWING COVER AND/OR MULCH.
- A PAD OF RUBBLE RIP RAP SHALL BE PLACED AT THE BOTTOM OF ALL COLLECTION FLUMES AND COLLECTION PIPE OUTLETS. GRANITE OR LIMESTONE RIPRAP IS REQUIRED. NO BROKEN CONCRETE WILL BE ACCEPTED.
- ALL SIDE SLOPES STEEPER THAN 3:1 SHALL BE ADEQUATELY PROTECTED FROM EROSION THROUGH THE USE OF HAY BALES OR SODDING.
- ALL STABILIZATION PRACTICES SHALL BE INITIATED AS SOON AS PRACTICABLE IN AREAS OF THE JOB WHERE CONSTRUCTION ACTIVITIES HAVE TEMPORARILY OR PERMANENTLY STOPPED, BUT IN NO CASE SHALL THE DISTURBED AREA BE LEFT UNPROTECTED FOR MORE THAN SEVEN DAYS.
- ALL WASTE GENERATED ON THE PROJECT SHALL BE DISPOSED OF BY THE CONTRACTOR IN AREAS PROVIDED BY CONTRACTOR.
- LOADED HAUL TRUCKS SHALL BE COVERED WITH TARPS.
- EXCESS DIRT SHALL BE REMOVED DAILY.
- THIS PROJECT SHALL COMPLY WITH ALL WATER QUALITY STANDARDS.
- QUALIFIED PERSONNEL SHALL INSPECT THE AREA USED FOR STORAGE OF STOCKPILES, THE SILT FENCE AND STRAW BALES. THE LOCATION WHERE VEHICLES ENTER OR EXIT THE SITE, AND THE DISTURBED AREAS THAT HAVE NOT BEEN FINALLY STABILIZED, AT LEAST ONCE EVERY SEVEN CALENDAR DAYS AND WITHIN 24 HOURS OF THE END OF A STORM OF 0.5 INCHES OR GREATER.
- SITES THAT HAVE BEEN FINALLY STABILIZED WITH SOD OR GRASSING SHALL BE INSPECTED AT LEAST ONCE EVERY WEEK.

NOTE: FOR ALL TYPE "A" LIGHTS A BLACK BAFFLE ACCESSORY IS TO BE INSTALLED. SEE CUT SHEETS PROVIDED FOR BLACK BAFFLE ACCESSORY.

**EXTERIOR LIGHTING SCHEDULE**

FIXTURE LABEL	MANUFACTURER AND CATALOG NUMBER	FIXTURE QUANTITY	LAMP TYPE, COLOR AND WATTAGE	FIXTURE MOUNTING TYPE	FIXTURE MOUNTING HEIGHT	STRUCTURE LOCATION	LOCATION OF FIXTURE	DRAWING SHEET NUMBER	LABELLED CUT SHEET PROVIDED	BAFFLE ACCES.
"A"	PROGRESS LIGHTING P5641	4	HALCO PAR 20 AMBER LED, 7.2 WATTS	WALL	8'-0" FROM FLOOR	SEE ABOVE	SEE ABOVE	C5	YES	YES

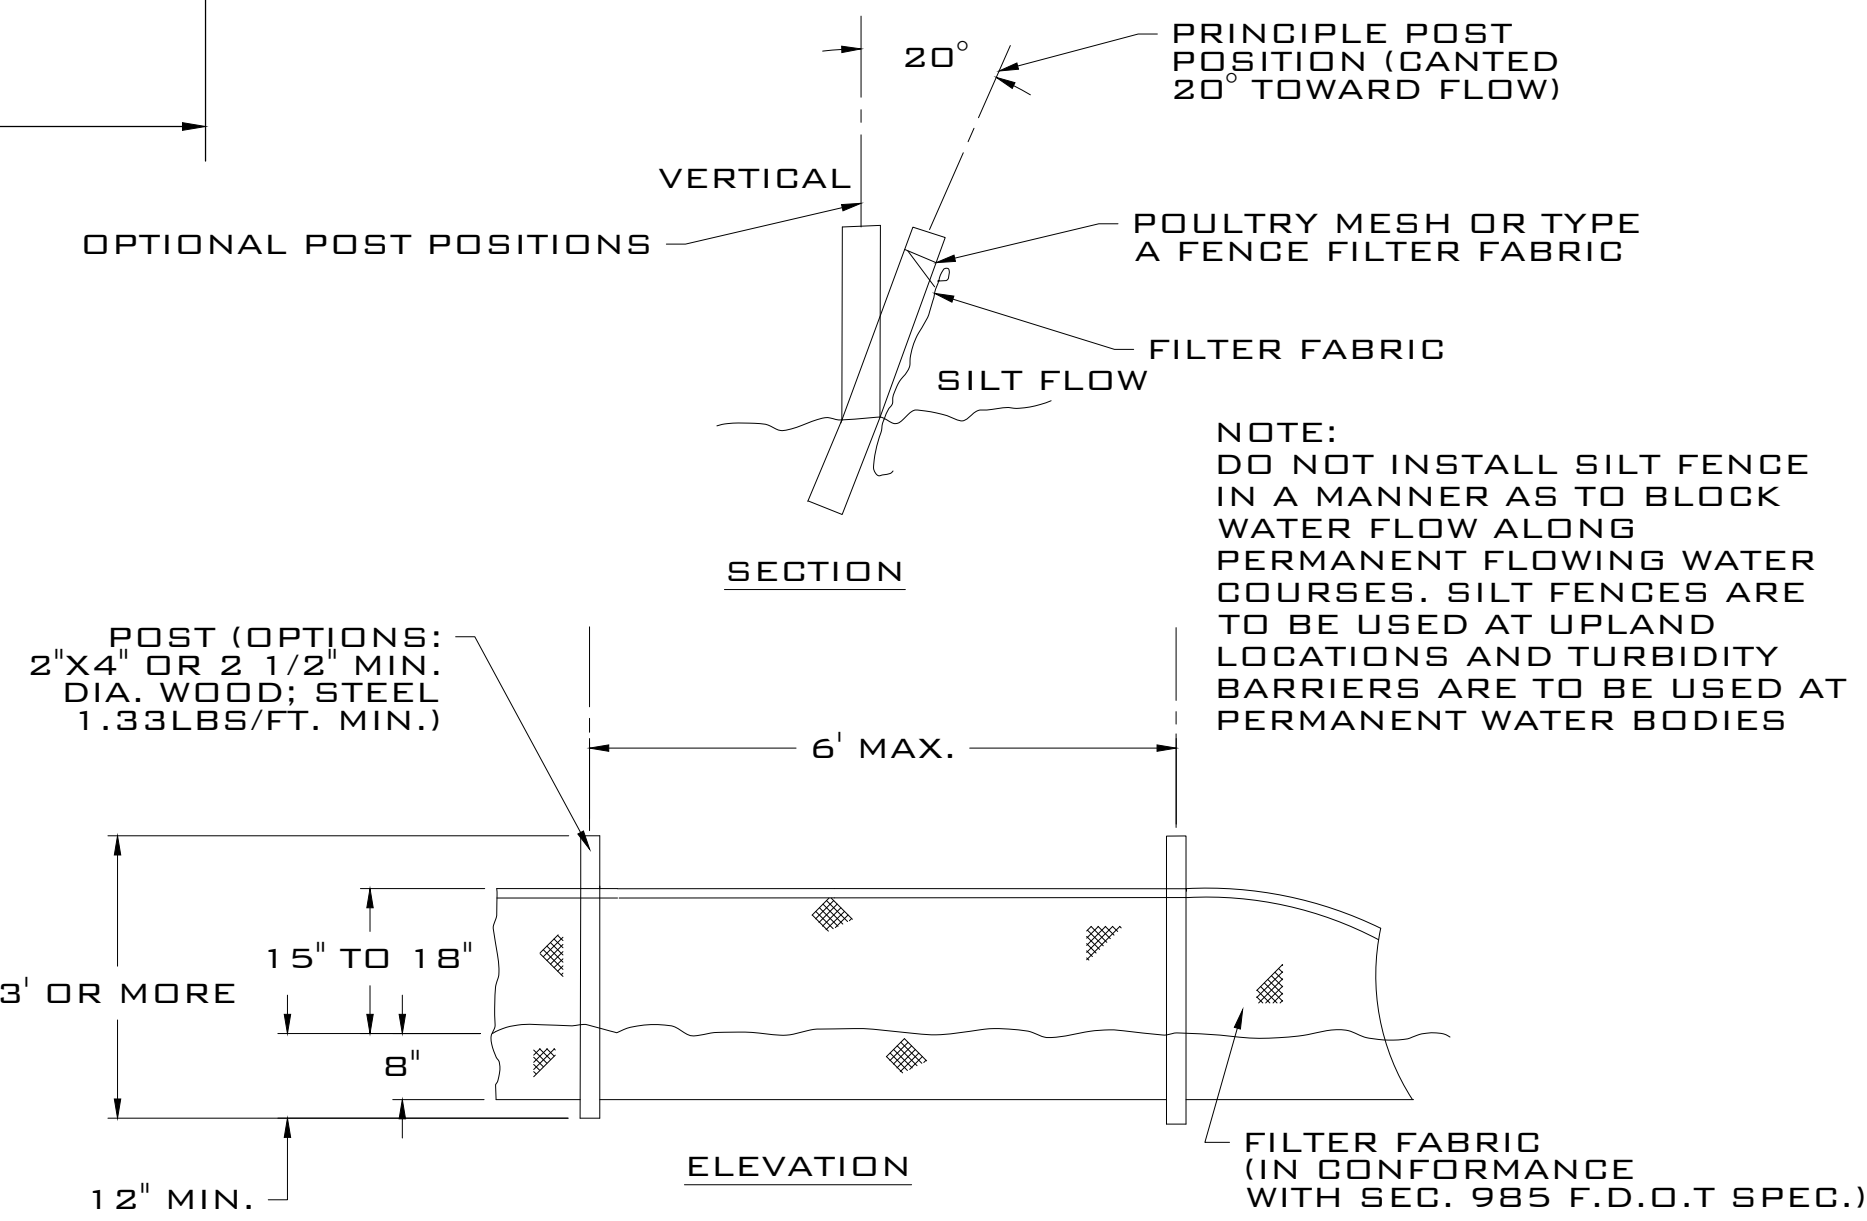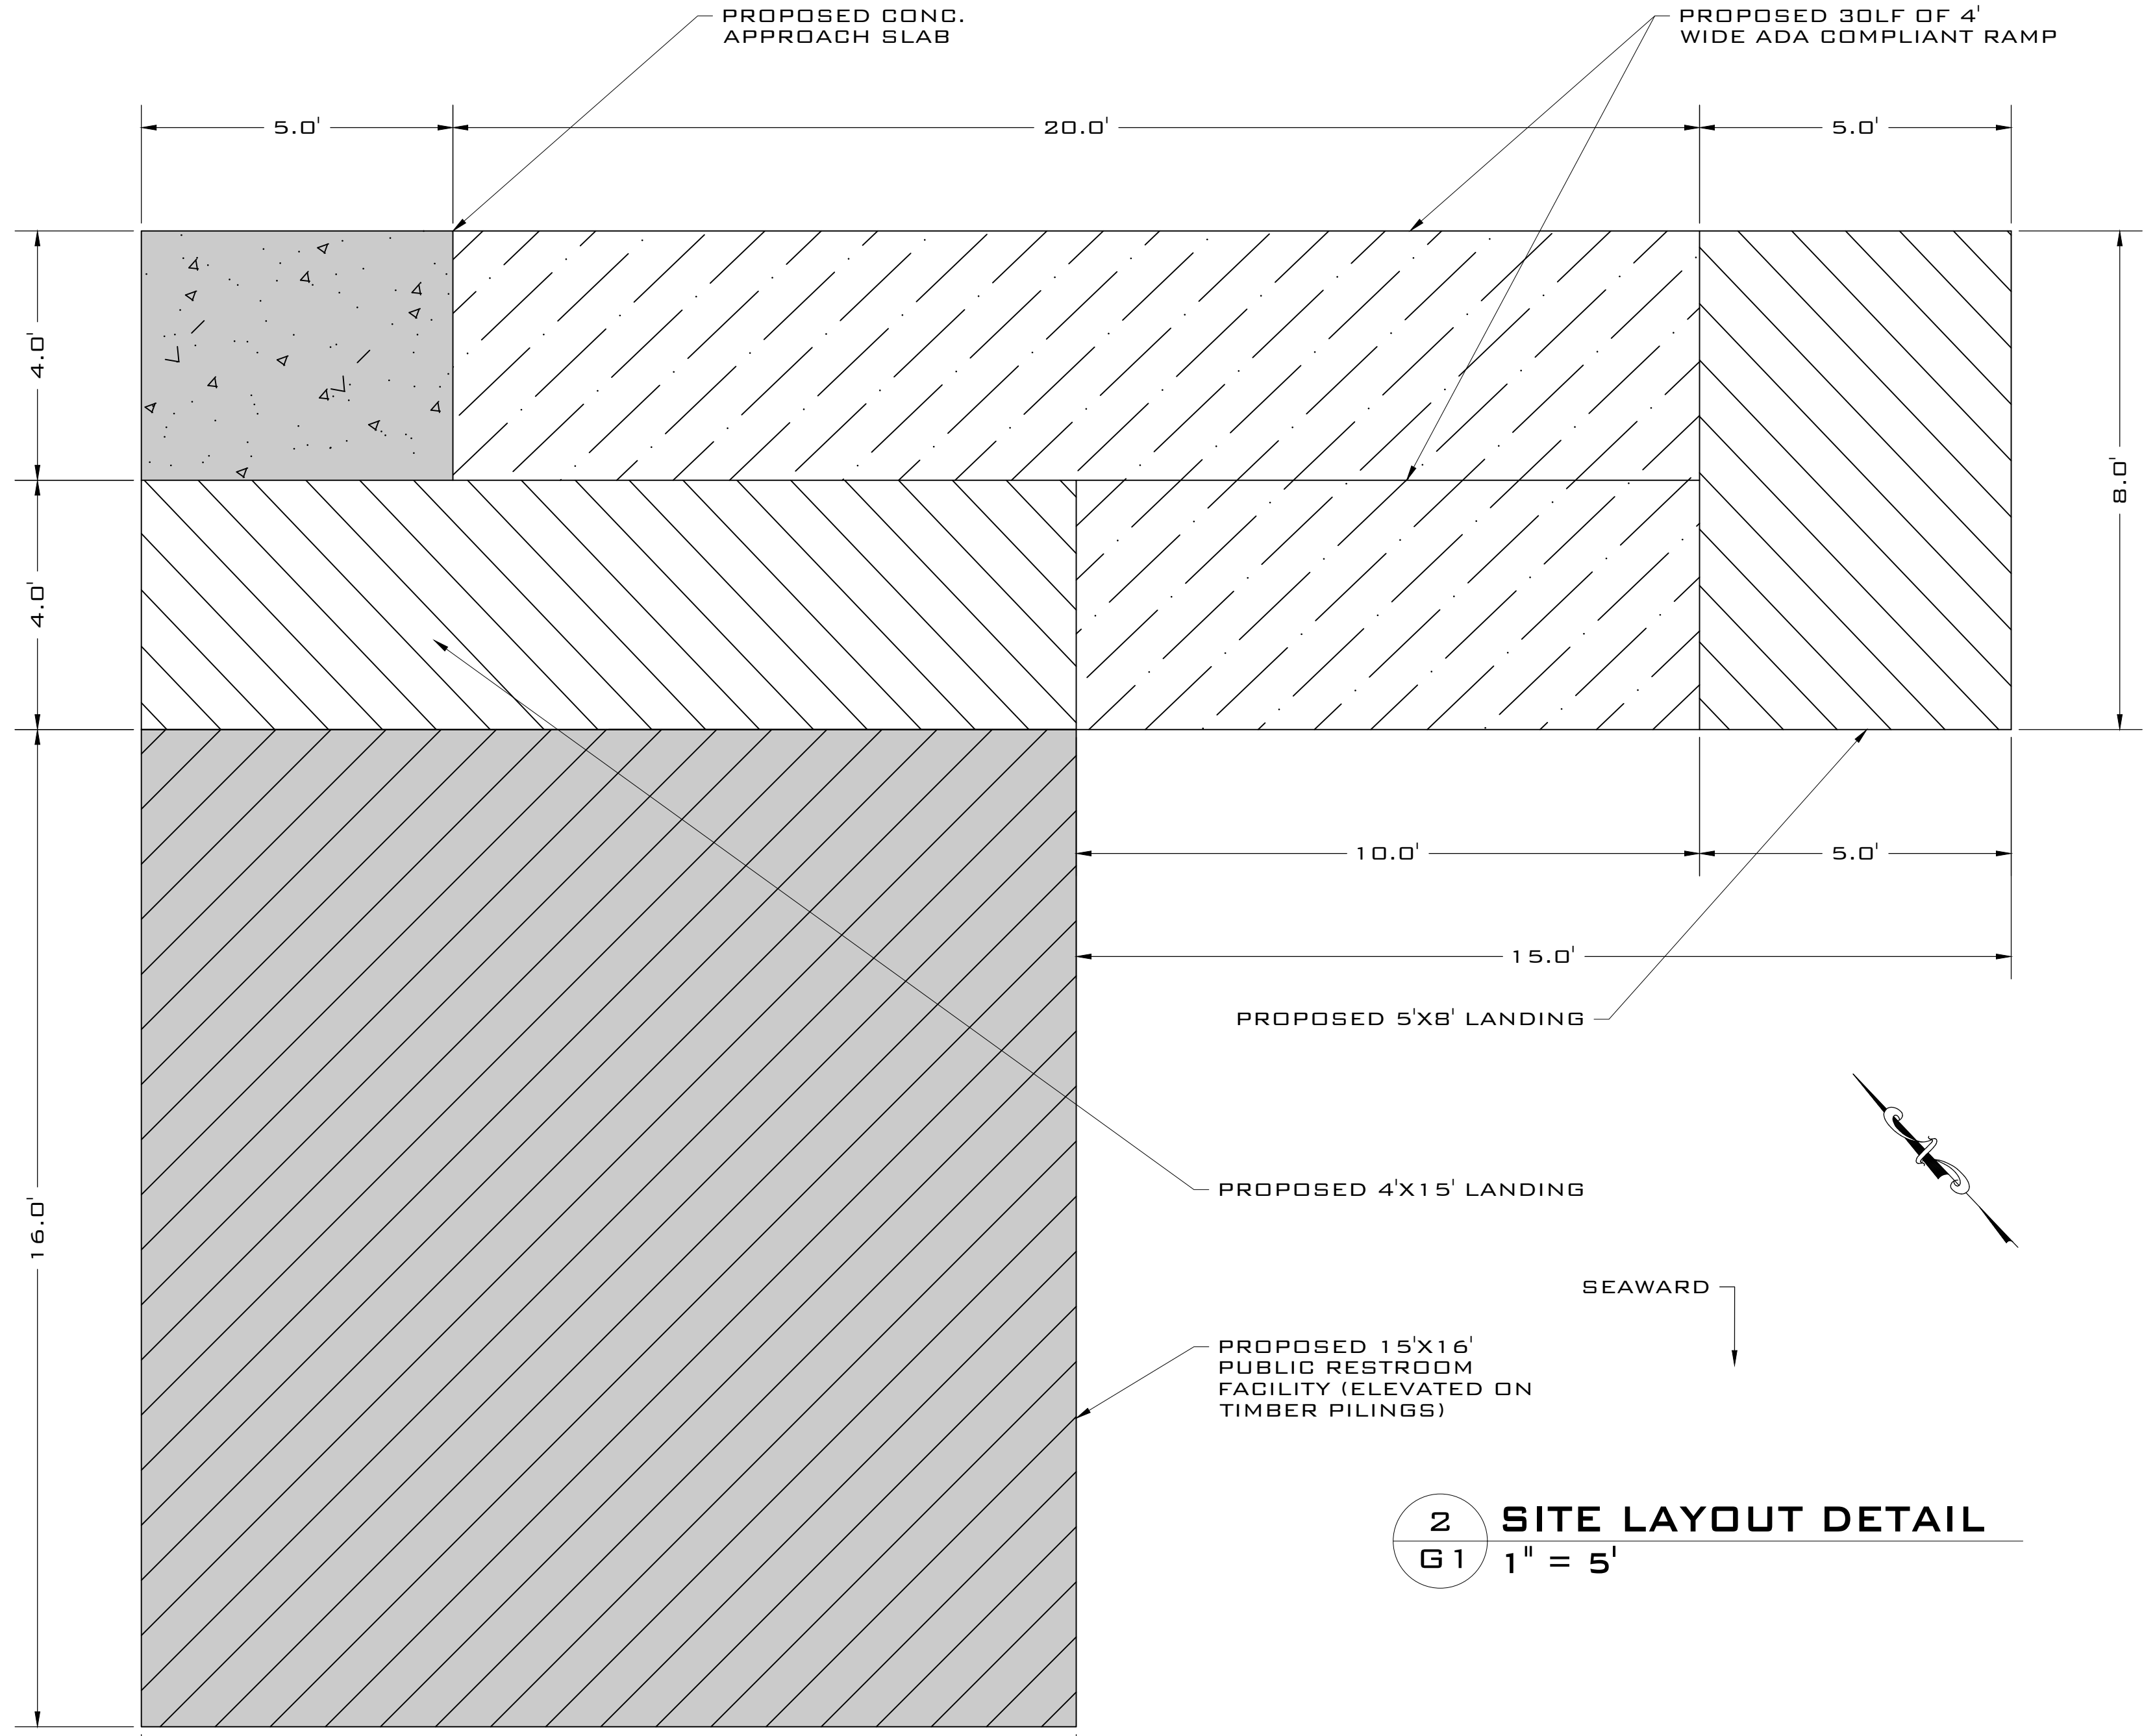

**SCE**  
**SOUTHEASTERN**  
 CONSULTING ENGINEERS, INC.  
 P.O. BOX 951  
 PORT ST. LUCIE, FL 32449  
 (850) 639-3860 (850) 227-1297  
 LB# 25064

**GENERAL NOTES**

7TH STREET BEACH RESTROOM BUILDING  
 HWY 98  
 MEXICO BEACH, FLORIDA 32410

PROJECT NUMBER: 21-167-14

DESIGNED BY: H.B. J. HUSBAND

CHECKED BY: J. HUSBAND

DRAWN BY: H.B. J. HUSBAND

DATE: 3/16/22

FOR: CITY OF MEXICO BEACH  
 201 PARADISE PATH  
 MEXICO BEACH, FL 32456



REVISIONS:

NO.	DATE	BY	ITEM



SHEET NO. **G1**

**SITE PLAN**  
 7TH STREET BEACH RESTROOM BUILDING  
 HWY 98  
 MEXICO BEACH, FLORIDA 32410


PROJECT NUMBER: 21-167-14	REVISIONS:
DESIGNED BY: H.B.	CHECKED BY: J. HUSBAND
DRAWN BY: H.B.	DATE:
FOR: CITY OF MEXICO BEACH 201 PARADISE PATH MEXICO BEACH, FL 32456	BY:
DATE: 3/16/22	ITEM:
SHEET NO. <b>C1</b>	

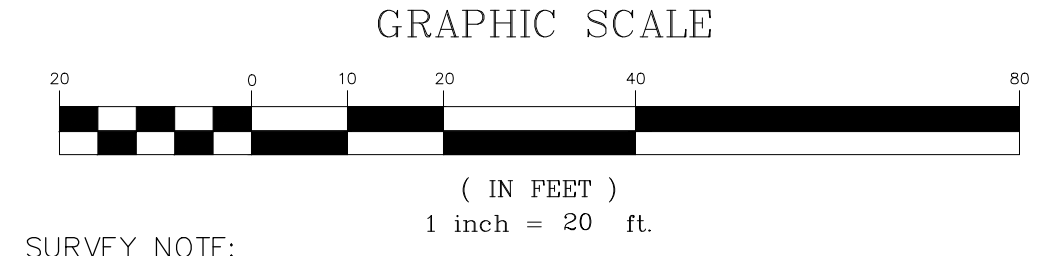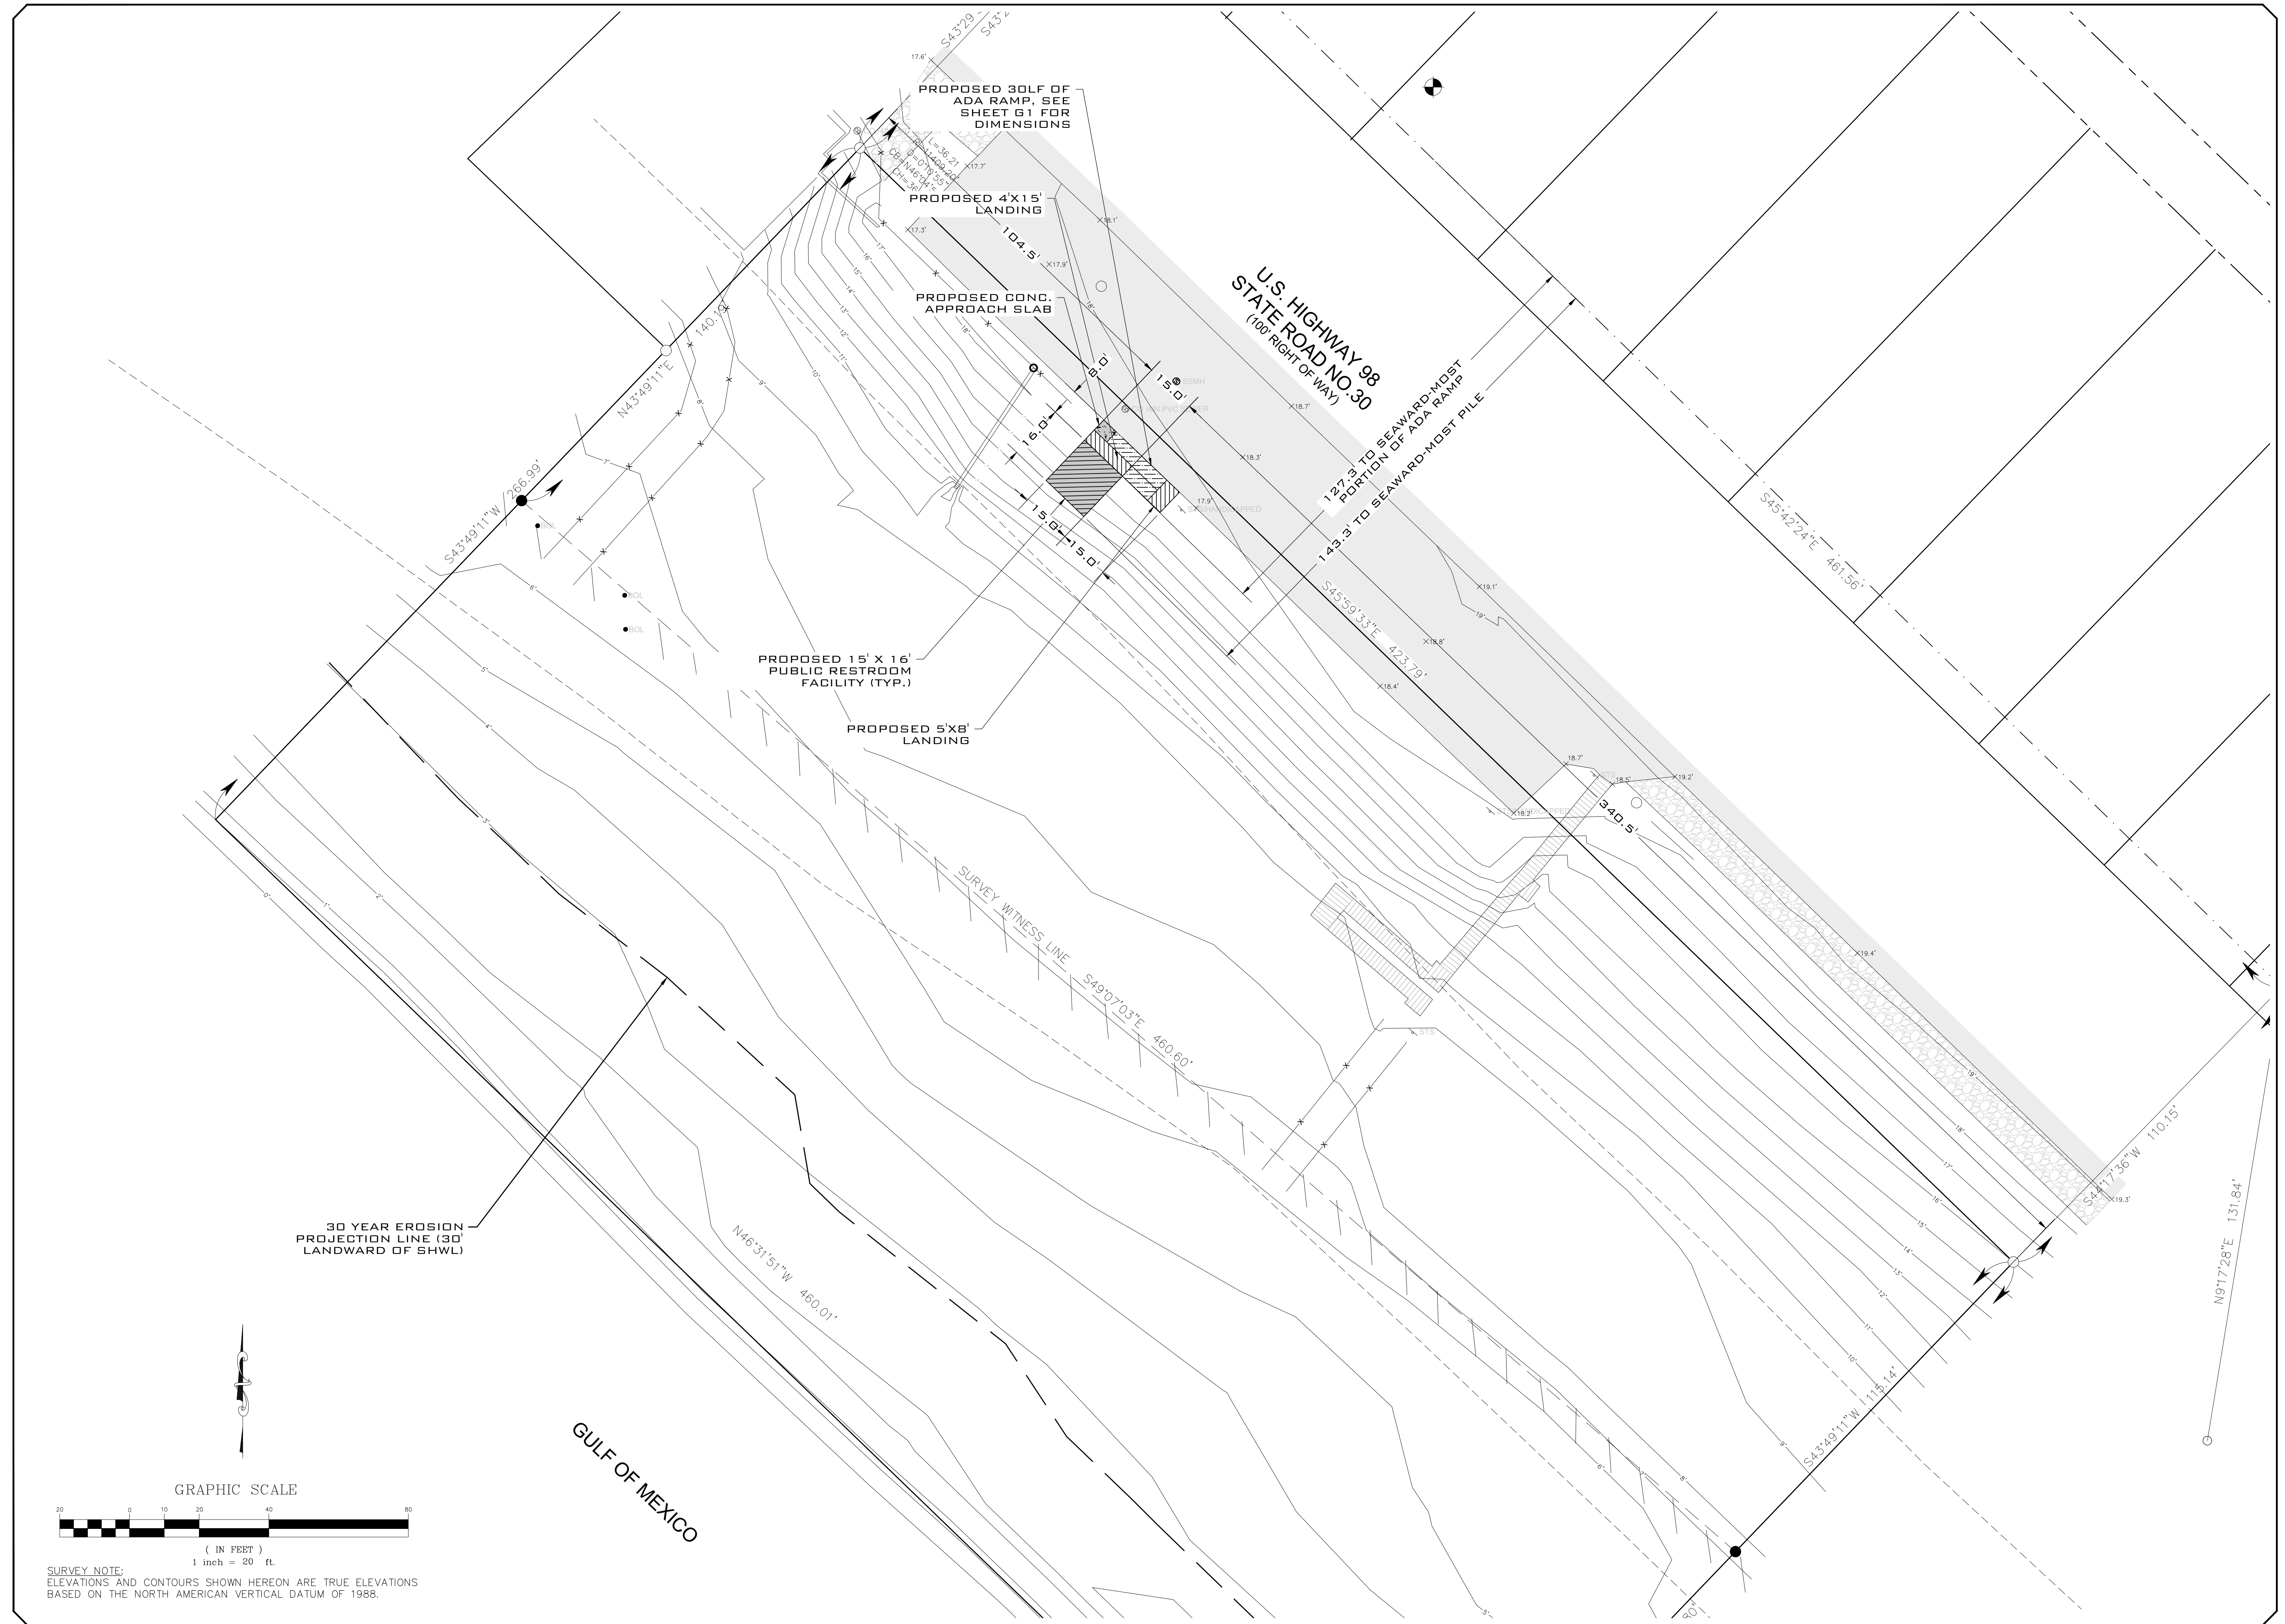

SURVEY NOTE:  
 ELEVATIONS AND CONTOURS SHOWN HEREON ARE TRUE ELEVATIONS  
 BASED ON THE NORTH AMERICAN VERTICAL DATUM OF 1988.

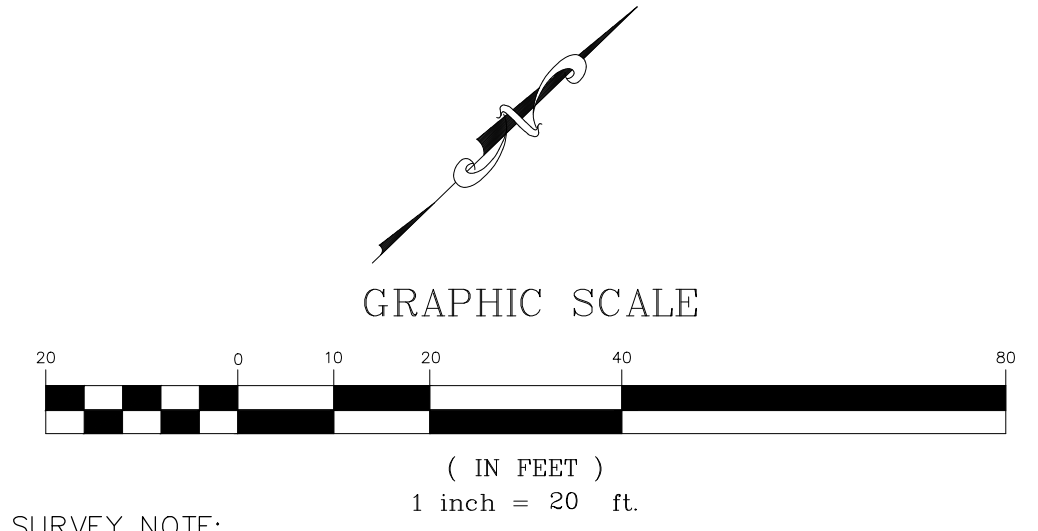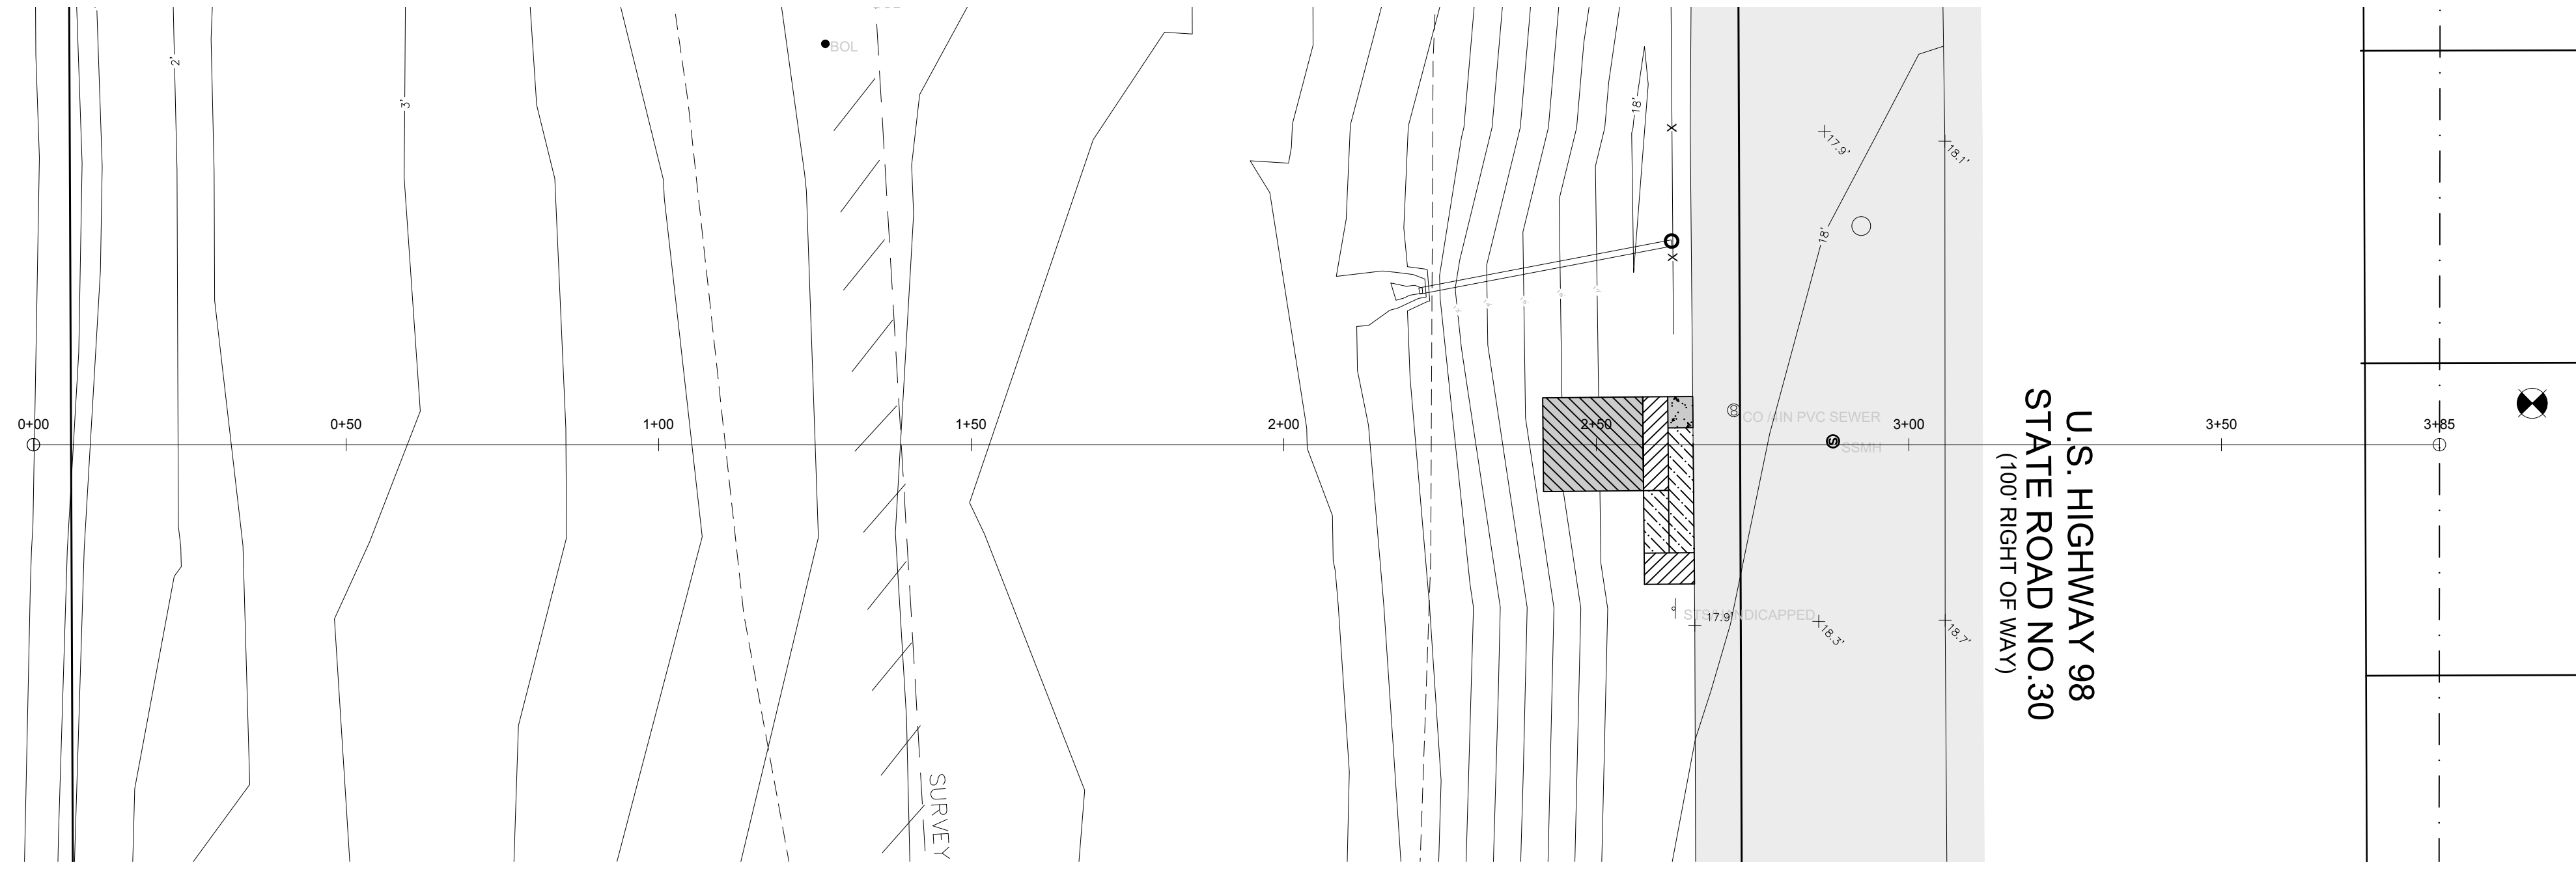

SURVEY NOTE:  
ELEVATIONS AND CONTOURS SHOWN HEREON ARE TRUE ELEVATIONS  
BASED ON THE NORTH AMERICAN VERTICAL DATUM OF 1988.

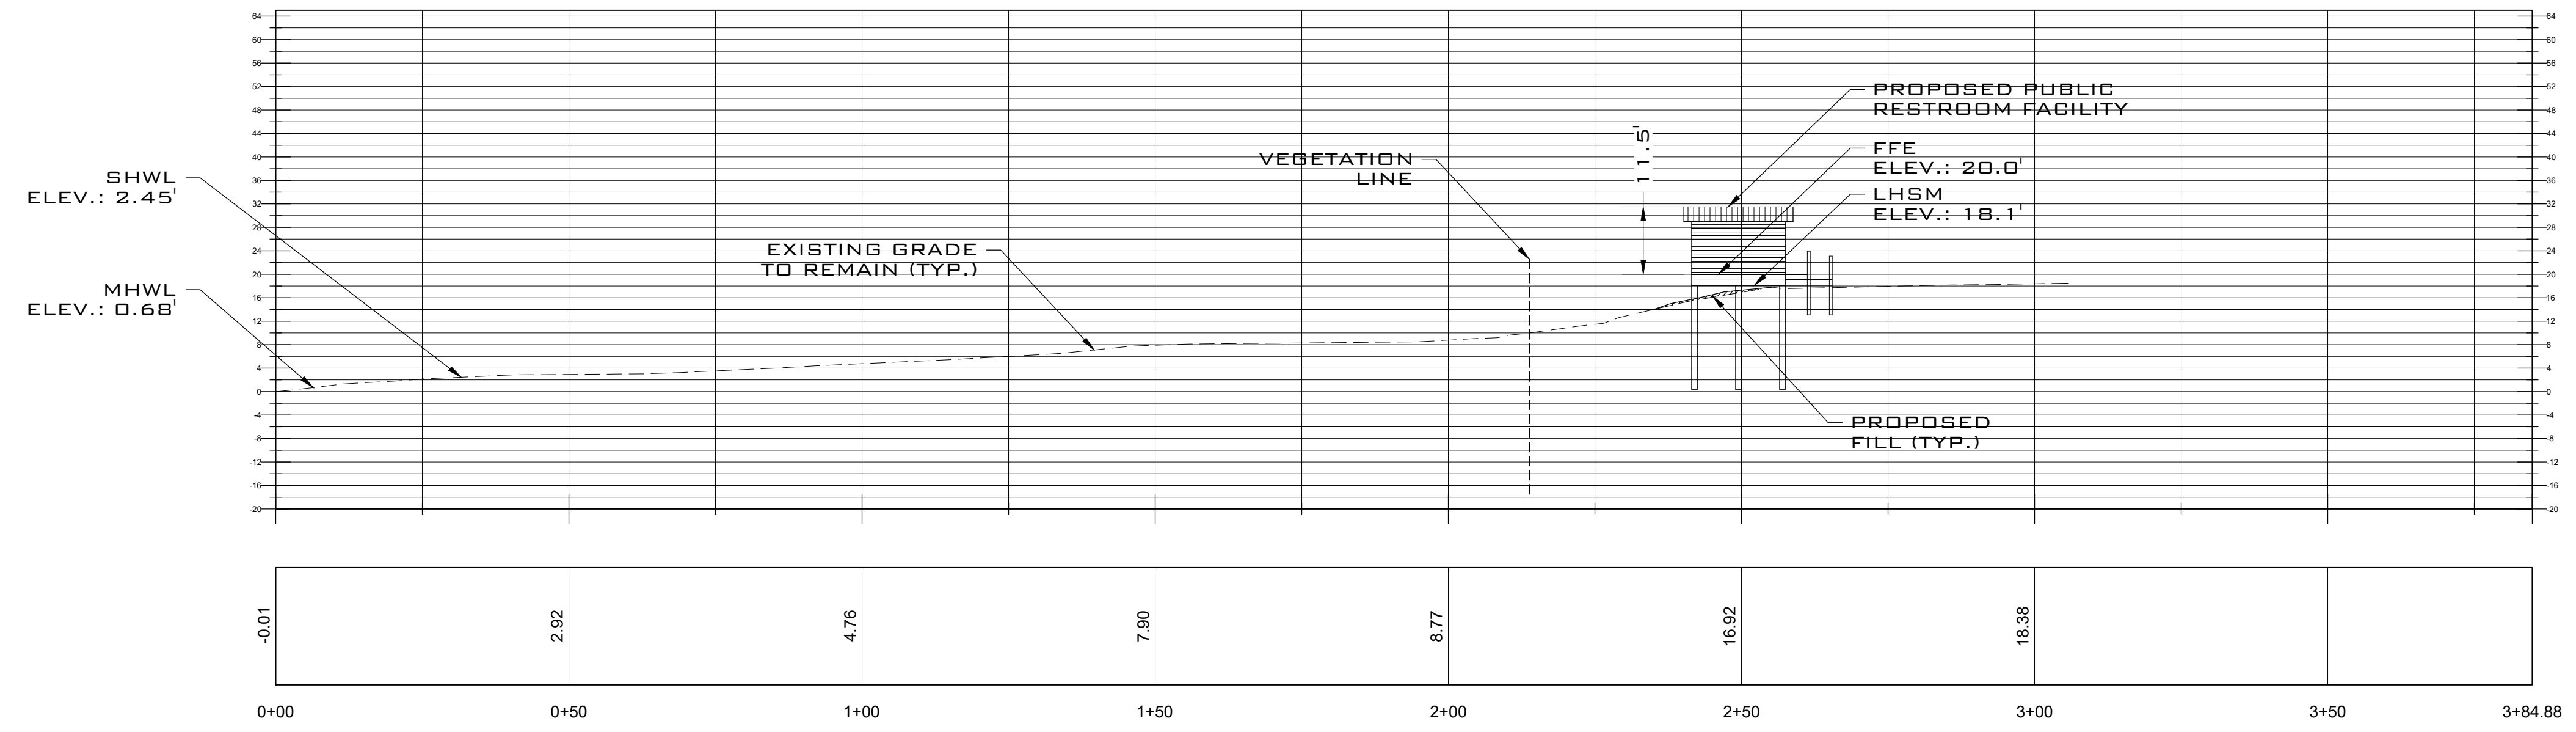

HORIZONTAL SCALE: 1" = 20'  
VERTICAL SCALE: 1" = 20'

**U.S. HIGHWAY 90**  
**PARADISE ROAD NO. 30**  
 (100' RIGHT OF WAY)


**GRADING PLAN**

7TH STREET BEACH RESTROOM BUILDING  
 HWY 98  
 MEXICO BEACH, FLORIDA 32410


PROJECT NUMBER: 21-167-14		REVISIONS:	
DESIGNED BY:	CHECKED BY:	DATE:	BY:
H.B.	J. HUSBAND		
FOR: CITY OF MEXICO BEACH 201 PARADISE PATH MEXICO BEACH, FL 32456			
DATE:	3/16/22		
SHEET NO.			
<b>03</b>			

- NOTE:**
1. NO CONSTRUCTION, OPERATION, TRANSPORTATION OR STORAGE OF MATERIALS, AND NO TEMPORARY LIGHTING OF THE CONSTRUCTION AREA IS AUTHORIZED IN MARINE TURTLE NESTING HABITAT, SEAWARD OF THE DUNE CREST, AT ANY TIME DURING THE MARINE TURTLE NESTING SEASON. (MAY 1 THROUGH OCTOBER 31)
  2. ALL CUT AND FILL PROVIDED IS FOR AREAS SEAWARD OF THE COOL.
  3. THE PROPOSED RESIDENCE WILL HAVE SEWER HOOKUP PROVIDED BY THE CITY OF MEXICO BEACH.
  4. ALL TEMPORARY STORAGE OF CUT/EXCAVATION MATERIAL SHALL BE LOCATED AT THE MOST PRACTICAL LANDWARD PORTION WITHIN THE PROPOSED CONSTRUCTION LIMITS.
  5. NO COMPACTION FACTORS HAVE BEEN TAKEN INTO ACCOUNT.
  6. ALL PROPOSED FILL MATERIAL SHALL MEET THE SPECIFICATIONS/CRITERIA OF SUBSECTION 62B-33.005(7), F.A.C.

CUT AND FILL TABLE				
AREA	FILL CF	CUT CF	FILL CY	CUT CY
SITE GRADE	193.28	N/A	7.16	N/A
		TOTAL	7.16	N/A
		NET	7.16	N/A

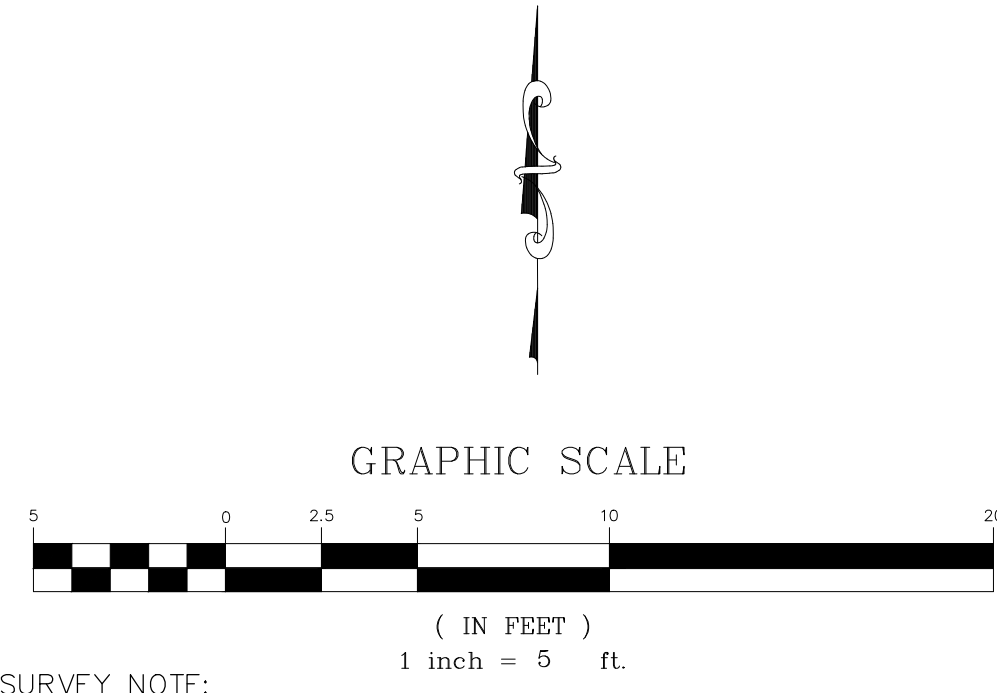

**SURVEY NOTE:**  
 ELEVATIONS AND CONTOURS SHOWN HEREON ARE TRUE ELEVATIONS BASED ON THE NORTH AMERICAN VERTICAL DATUM OF 1988.

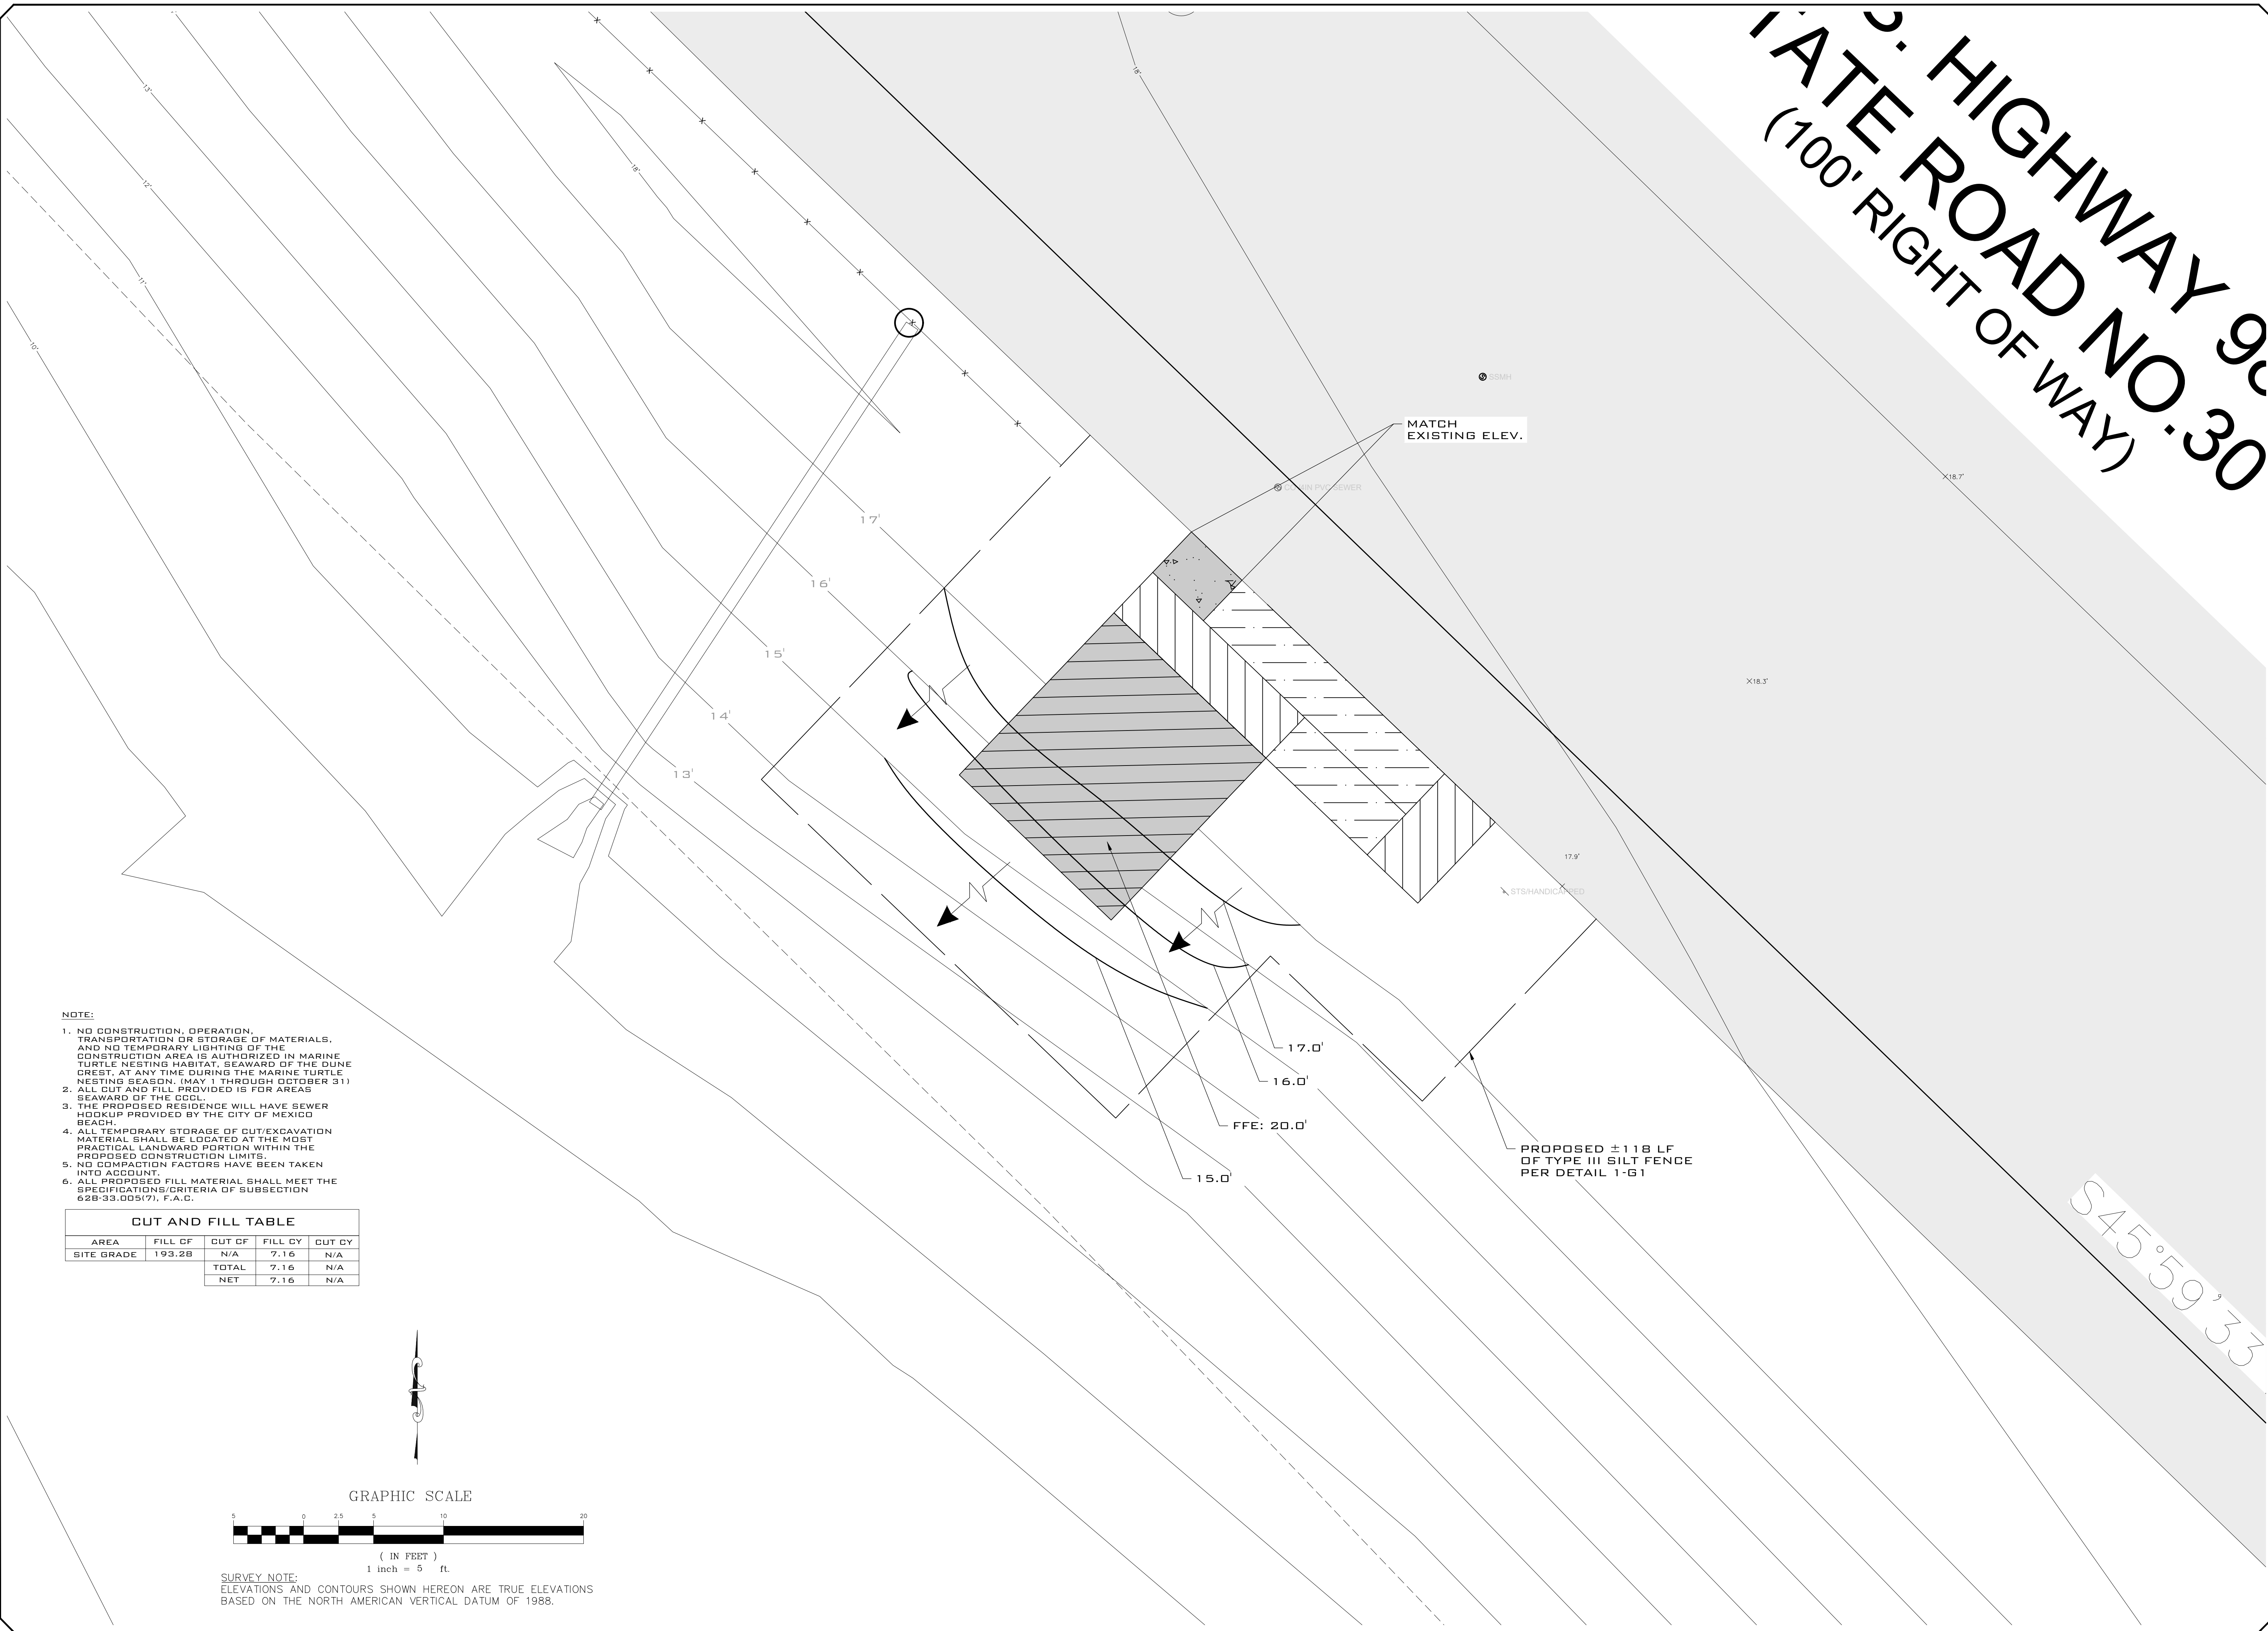


U.S. HIGHWAY 90  
 STATE ROAD NO. 30  
 (100' RIGHT OF WAY)

**SCCE**  
 SOUTHEASTERN  
 CONSULTING ENGINEERS, INC.  
 P.O. BOX 951  
 WEAVER, FL 32465  
 (850) 639-3860 (850) 227-1297  
 LB# 29064


PLANTING PLAN

7TH STREET BEACH RESTROOM BUILDING  
 HWY 98  
 MEXICO BEACH, FLORIDA 32410

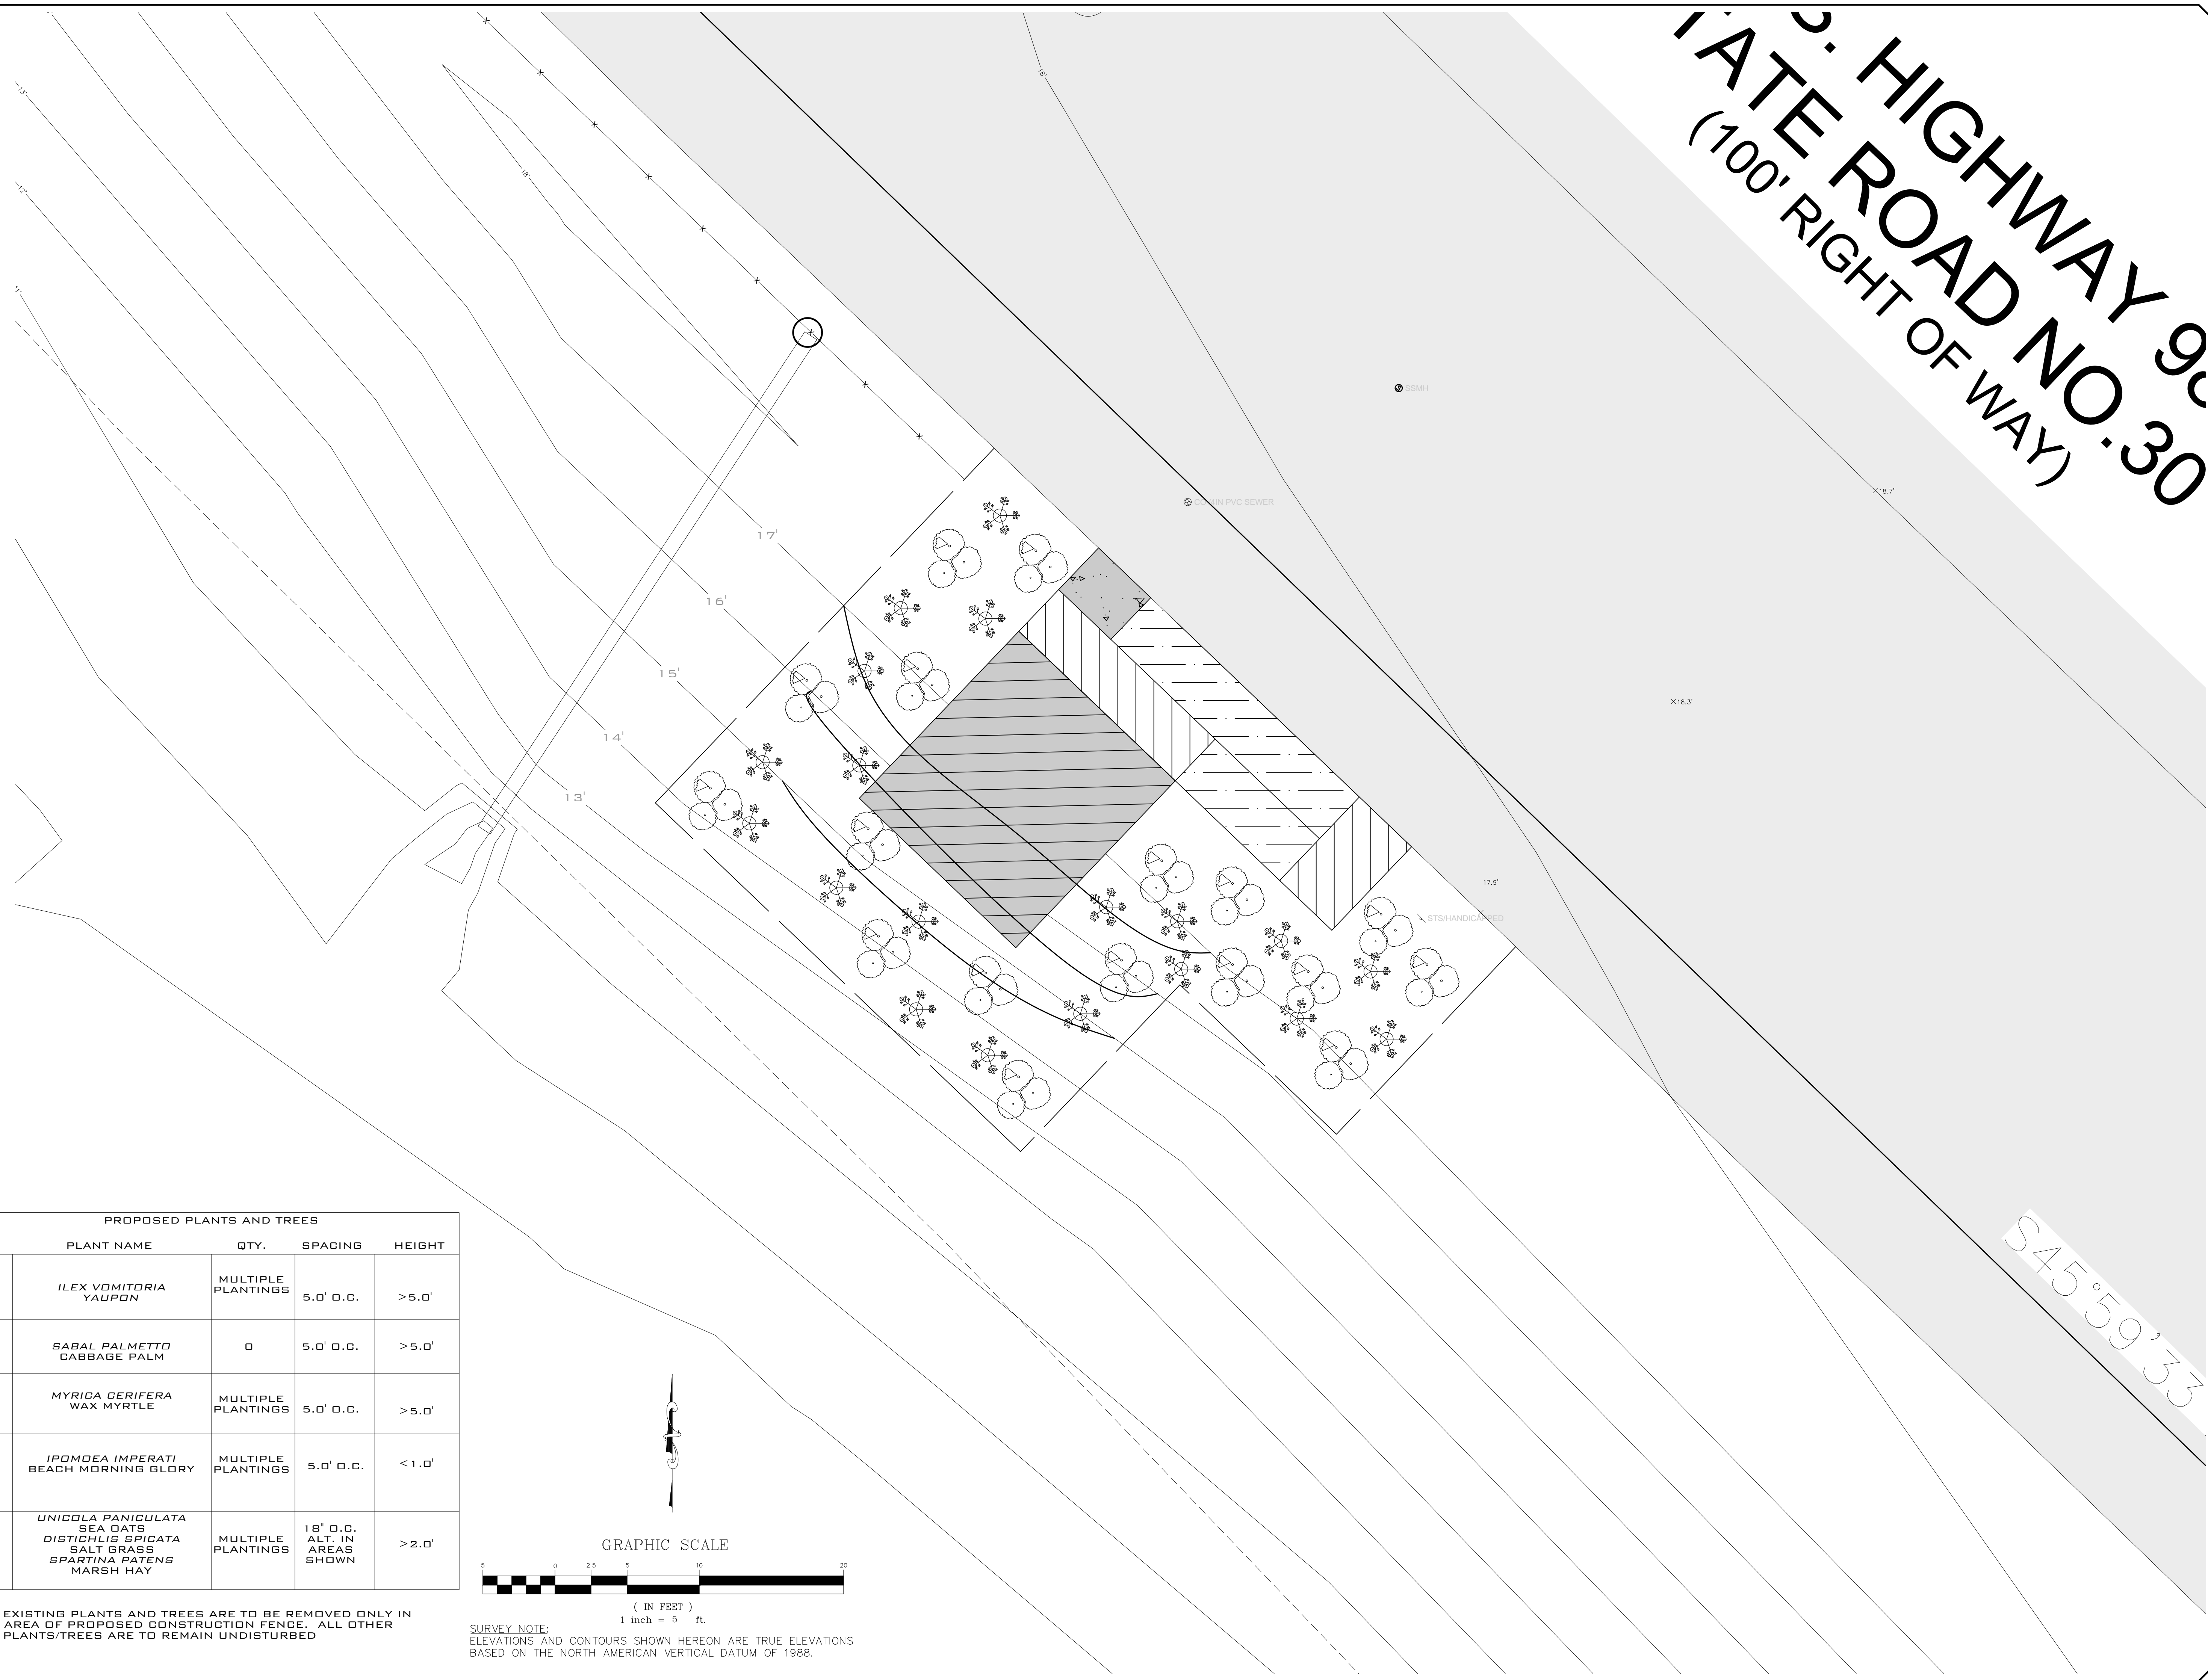

PROPOSED PLANTS AND TREES

SYMBOL	PLANT NAME	QTY.	SPACING	HEIGHT
	<i>ILEX VOMITORIA</i> YAUPON	MULTIPLE PLANTINGS	5.0' O.C.	>5.0'
	<i>SABAL PALMETTO</i> CABBAGE PALM	0	5.0' O.C.	>5.0'
	<i>MYRICA CERIFERA</i> WAX MYRTLE	MULTIPLE PLANTINGS	5.0' O.C.	>5.0'
	<i>IPOMOEA IMPERATI</i> BEACH MORNING GLORY	MULTIPLE PLANTINGS	5.0' O.C.	<1.0'
	<i>UNICOLA PANICULATA</i> SEA OATS <i>DISTICHLIS SPICATA</i> SALT GRASS <i>SPARTINA PATENS</i> MARSH HAY	MULTIPLE PLANTINGS	18" O.C. ALT. IN AREAS SHOWN	>2.0'

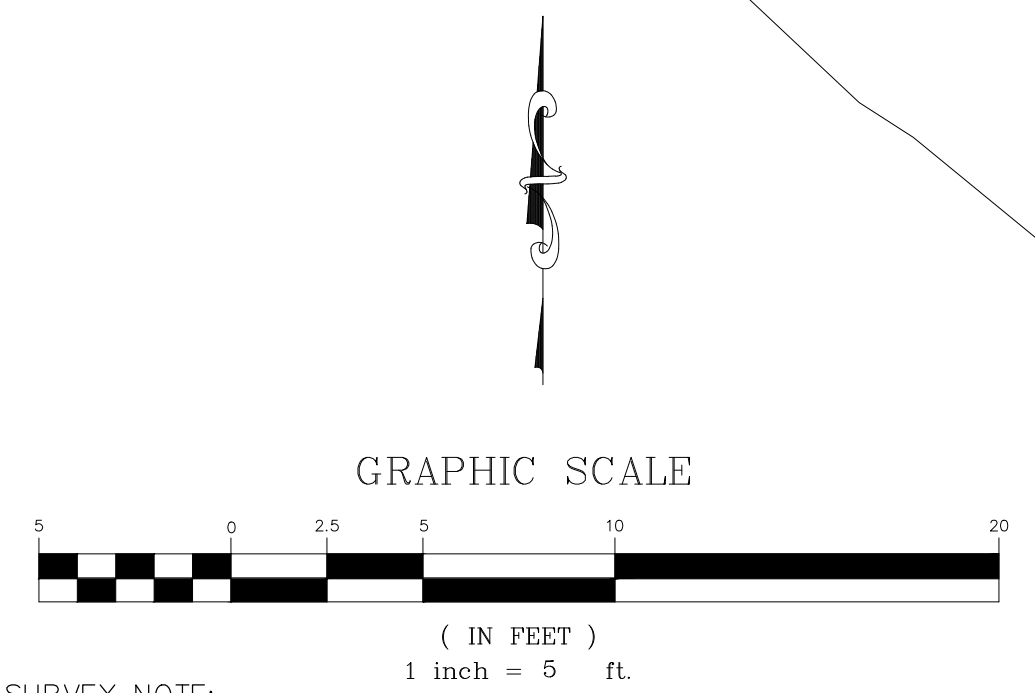

NOTE: EXISTING PLANTS AND TREES ARE TO BE REMOVED ONLY IN AREA OF PROPOSED CONSTRUCTION FENCE. ALL OTHER PLANTS/TREES ARE TO REMAIN UNDISTURBED

SURVEY NOTE:  
 ELEVATIONS AND CONTOURS SHOWN HEREON ARE TRUE ELEVATIONS BASED ON THE NORTH AMERICAN VERTICAL DATUM OF 1988.

S45°59'33"

PROJECT NUMBER: 21-167-14


DESIGNED BY:	DRAWN BY:	CHECKED BY:	DATE	BY	ITEM
H.B.	H.B.	J. HUSBAND			

FOR: CITY OF MEXICO BEACH  
 201 PARADISE PATH  
 MEXICO BEACH, FL 32456

DATE: 3/16/22  
 SHEET NO. C4

CITY OF MEXICO BEACH  
7TH STREET BEACH  
RESTROOM  
FEMA REPAIR  
BAY COUNTY  
FLORIDA

C:\USERS\REISEN\DOCUMENTS\8TH STREET BATHROOM\MEXICO BEACH\8TH STREET BEACH RESTROOM.DWG

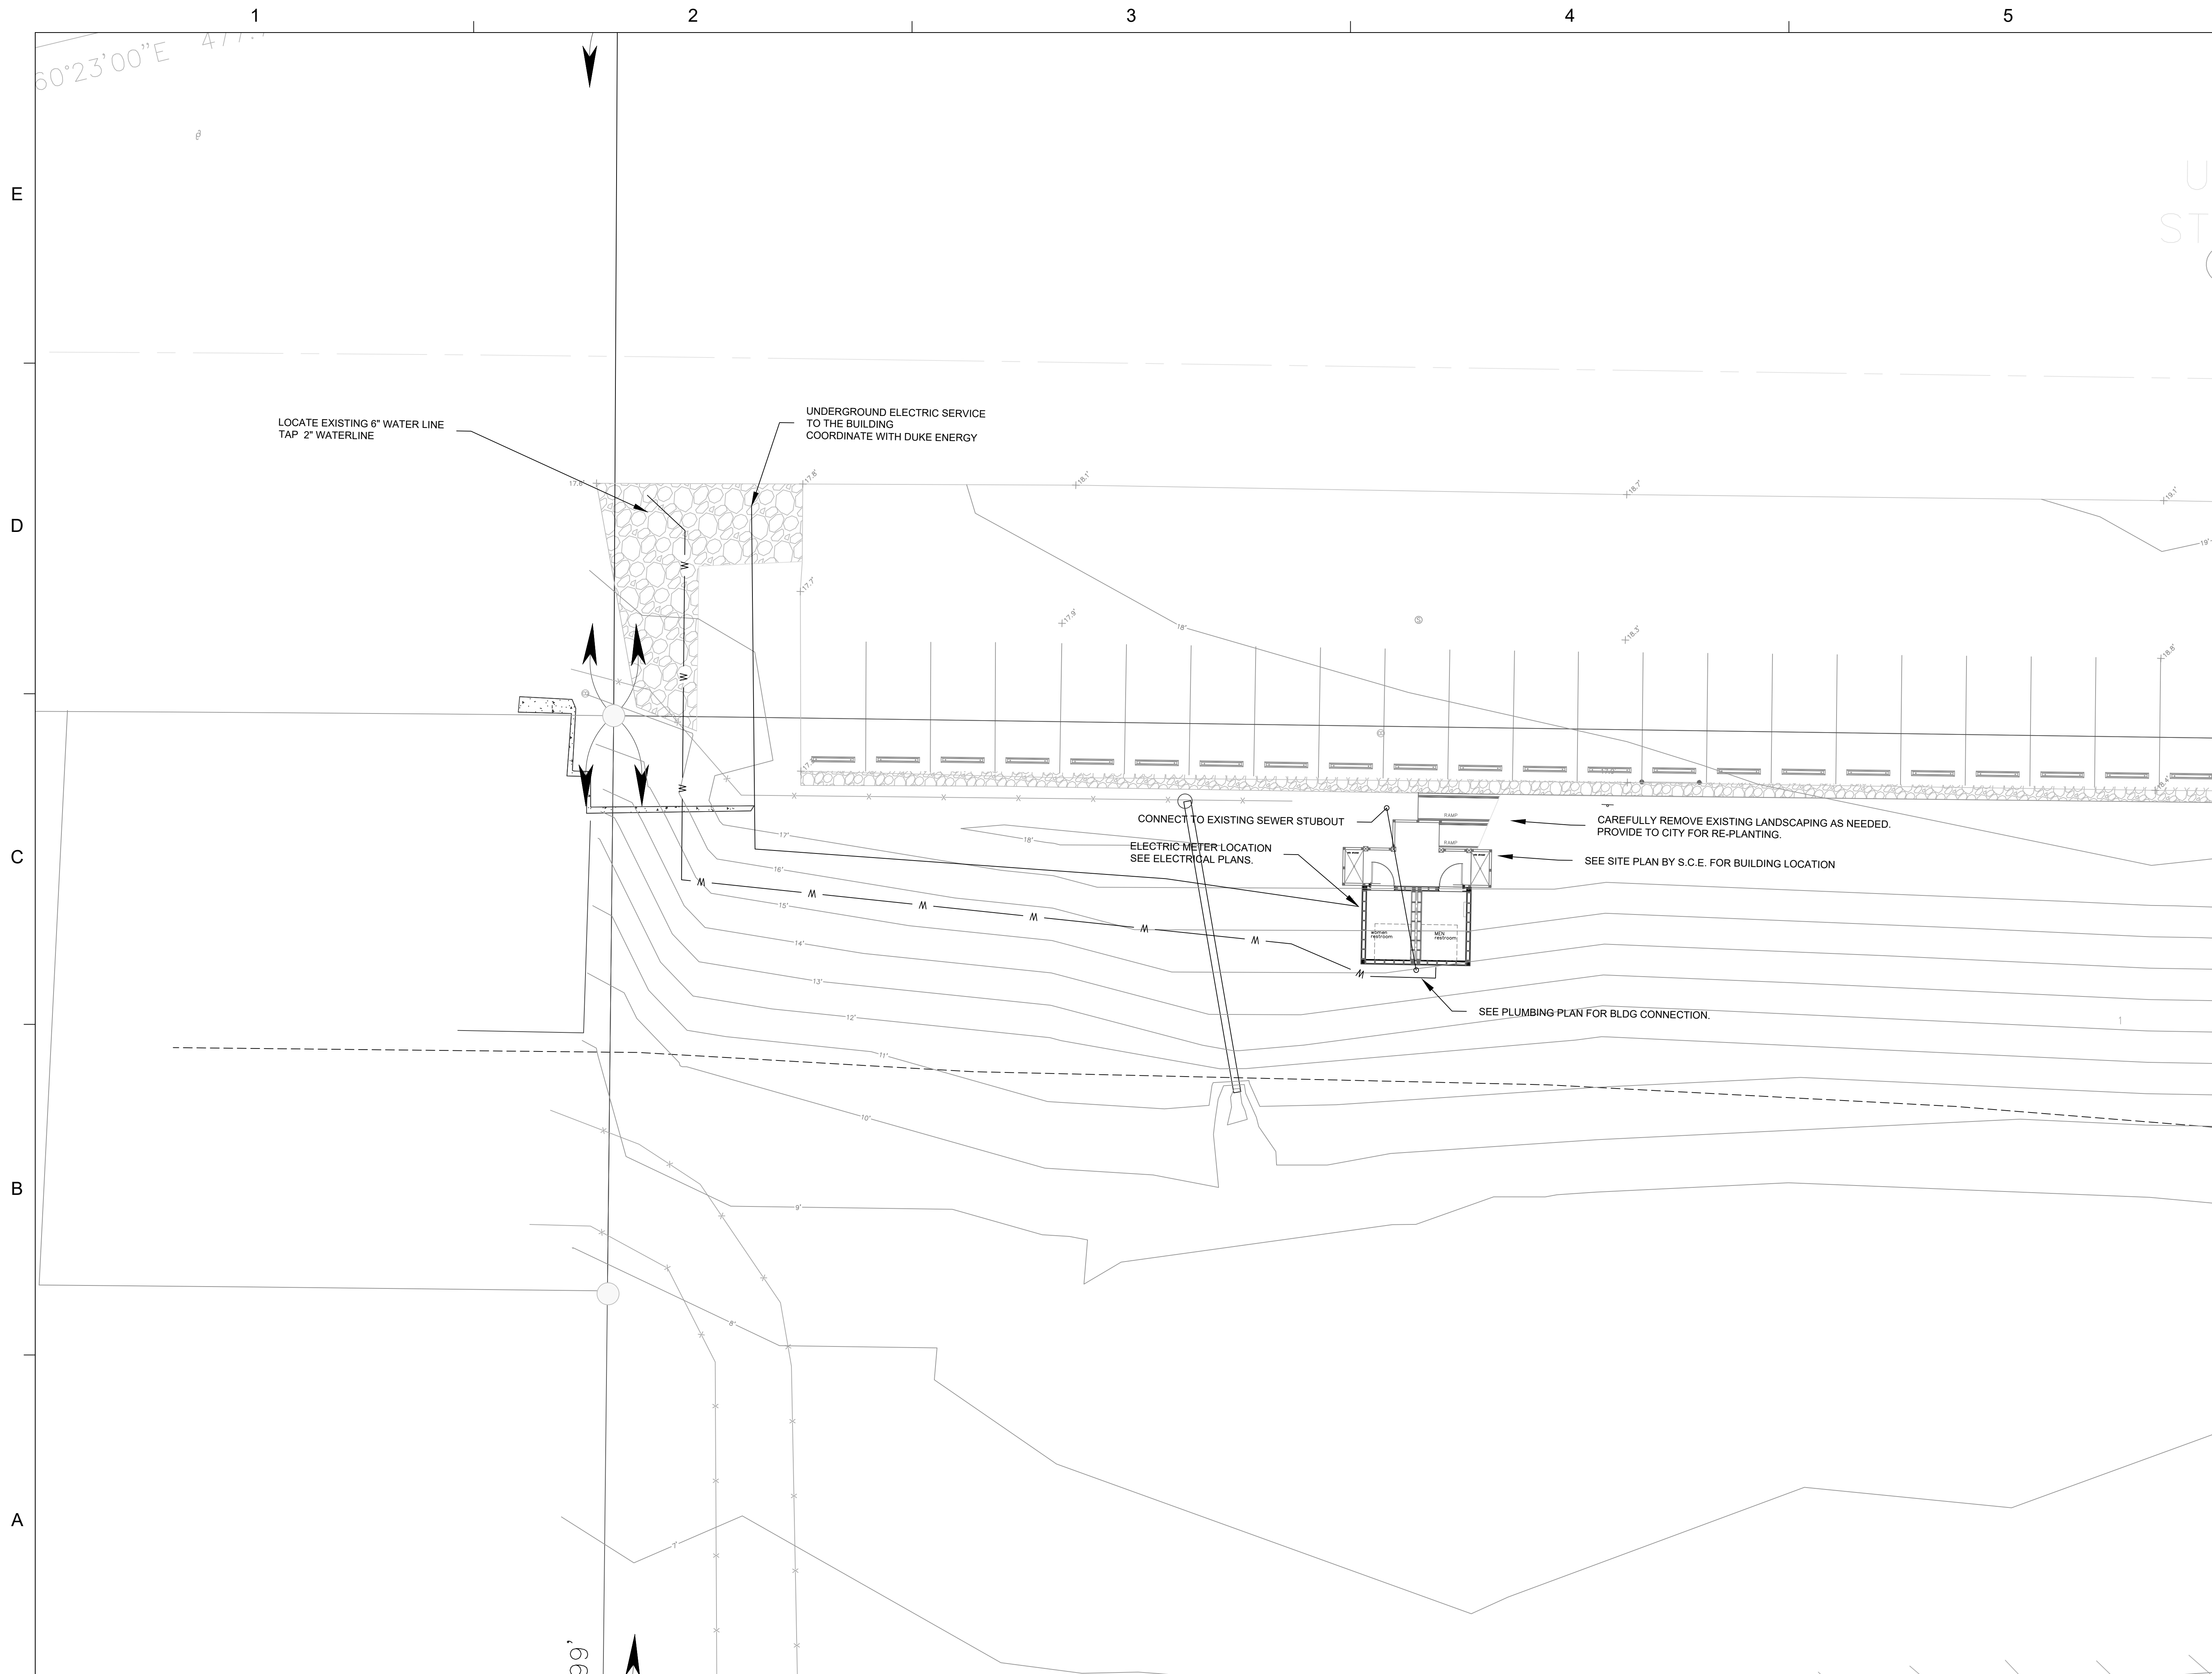


SEAL

EB 0008794

FOR BIDDING

SCALE

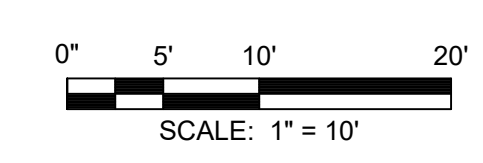

REVISIONS

NO.	DESCRIPTION	DATE

DRAWN BY \_\_\_\_\_  
 APPROVED BY \_\_\_\_\_ D.REISEN  
 CHECKED BY \_\_\_\_\_  
 DATE \_\_\_\_\_ OCTOBER 2022

TITLE  
**UTILITY PLAN**

PROJECT NO. 50112879

**U-1**

SHEET NO.



# 7TH STREET BEACH RESTROOMS BAY COUNTY FLORIDA

## SYMBOL LEGEND

MATERIAL SYMBOLS	
EARTH	PLYWOOD
GRANULAR FILL	ACOUSTICAL OR CERAMIC TILE
CONCRETE	CMU/PLASTER/STUCCO/GROUT
CONCRETE MASONRY UNIT	ROAD INSULATION
BRICK	FIRE SAFING/COMP FILLER
FINISHED WOOD	BATT INSULATION
ROUGH WOOD (CONTINUOUS)	LATH
ROUGH WOOD (NOT CONTINUOUS)	BIT DAMPROOFING

GENERAL SYMBOLS	
DETAIL NUMBER	DETAIL TITLE
SHEET REFERENCE	SCALE 1/4"=1'-0"
SECTION NUMBER	BUILDING SECTION
SHEET REFERENCE	
SECTION NUMBER	SECTION CUTS
SHEET REFERENCE	
NAME	ROOM NAME
SUMM	ROOM NUMBER
⊙	DOOR MARK
⊕	WINDOW MARK
⊞	WALL TYPE MARK
12'-4"	FINISH FLOOR ELEVATION
⊕	INTERIOR ELEVATION
⊕	COLUMN REFERENCE AND GRID LINES

ABBREVIATIONS					
ACT	ACUSTICAL TILE	FON	FOUNDATION	OC	ON CENTER(S)
AD	AREA DRAIN	FE	FIRE EXTINGUISHER	OFD	OWNER FURNISHED
AE	ARCHITECT-ENGINEER	FEC	FIRE EXTINGUISHER CABINET	OFI	OWNER INSTALLED
AHJ	Above FINISHED FLOOR	FHC	FIRE HOSE CABINET	OFOR	OWNER FURNISHED
APPROX	APPROXIMATE	FIN	FINISHED	OFORH	OWNER FURNISHED
ARCH	ARCHITECTURAL	FL	FLOOR	ORH	OPPOSITE HAND
BD	BOARD	FD	FACE OF	ORPH	OPPOSITE
BT	BITUMINOUS	FT	FOOT/FEET	ORPH	OPPOSITE
BLDG	BUILDING	FTG	FOOTING	ORPH	OPPOSITE
BLK	BLOCK	GA	GAGE/GAUGE	ORPH	OPPOSITE
BLKG	BLOCKING	GAU	GALVANIZED	ORPH	OPPOSITE
BM	BEAM	GL	GLASS/GLAZING	ORPH	OPPOSITE
BTM	BOTTOM	GSB	GYPSON WALL BOARD	ORPH	OPPOSITE
BRG	BEARING	GYP	GYPSON	ORPH	OPPOSITE
BRK	BRICK	HYP	HANDICAP ACCESSIBLE	ORPH	OPPOSITE
BUR	BUILT UP ROOFING	HA	HANDICAP ACCESSIBLE	ORPH	OPPOSITE
CEM PL	CEMENT PLASTER	HOW	HOLLOW METAL	ORPH	OPPOSITE
CFI	CONTRACTOR FURNISHED	HM	HOLLOW METAL	ORPH	OPPOSITE
CFI	CONTRACTOR INSTALLED	HR	HOUR	ORPH	OPPOSITE
CHEM	CHEMICAL	HT	HEAT/HIGH	ORPH	OPPOSITE
CJ	CONTROL JOINT/CONSTRUCTION JOINT	HVAC	HEATING, VENTILATING AND AIR CONDITIONING	ORPH	OPPOSITE
CL	CENTER LINE	ID	INSE DDIAMETER	ORPH	OPPOSITE
CLG	CEILING	IN	INCH	ORPH	OPPOSITE
CMU	CONCRETE MASONRY UNIT	INSUL	INSULATED(ION)	ORPH	OPPOSITE
COL	COLUMN	INT	INTERIOR	ORPH	OPPOSITE
CONC	CONCRETE	IT	JOINT	ORPH	OPPOSITE
CONF	CONFERENCE	JT	JOINT	ORPH	OPPOSITE
CONT	CONTINUOUS	L	LENGTH	ORPH	OPPOSITE
CPT	CORPATED	LAV	LAVATORY	ORPH	OPPOSITE
CT	CERAMIC TILE	LAV	LAVATORY	ORPH	OPPOSITE
CT	DEMOLITION	LF	LINEAL FEET	ORPH	OPPOSITE
DET	DETAIL	MAX	MAXIMUM	ORPH	OPPOSITE
DF	DRINKING FOUNTAIN	MCH	MECHANICAL	ORPH	OPPOSITE
DA	DIAMETER	MET	METAL	ORPH	OPPOSITE
DM	DIMENSION	MFR	MANUFACTURE(R)	ORPH	OPPOSITE
DV	DIVISION	MIS	MISCELLANEOUS	ORPH	OPPOSITE
DN	DOWN	MISC	MISCELLANEOUS	ORPH	OPPOSITE
DR	DOOR	N	NORTH	ORPH	OPPOSITE
DWG	DRAWING(S)	NA	NOT APPLICABLE	ORPH	OPPOSITE
E	EAST	NIC	NOT IN CONTRACT	ORPH	OPPOSITE
EJ	EXPANSION JOINT	NO	NUMBER	ORPH	OPPOSITE
EL	ELEVATION	NOM	NOMINAL	ORPH	OPPOSITE
ELEC	ELECTRICAL	NTS	NOT TO SCALE	ORPH	OPPOSITE
ELEV	ELEVATOR			ORPH	OPPOSITE
EQ	EQUIPMENT			ORPH	OPPOSITE
EQ	EQUIPMENT			ORPH	OPPOSITE
EXP	EXPOSED			ORPH	OPPOSITE
EXT	EXTERIOR			ORPH	OPPOSITE

## GENERAL NOTES

1. ALL WORK SHALL BE IN ACCORDANCE WITH THE CODES REFERENCED IN THESE DOCUMENTS AND AS ADOPTED AND SUPPLEMENTED BY LOCAL REGULATIONS.
2. THE CONTRACTOR SHALL BE RESPONSIBLE FOR ACQUIRING ALL BUILDING PERMITS FROM THE LOCAL BUILDING DEPARTMENTS AS REQUIRED BY CITY/COUNTY REGULATIONS. FEES FOR SUCH PERMITS SHALL BE PAID BY THE CONTRACTOR AND A SET OF APPROVED DRAWINGS AND ORIGINAL PERMITS SHALL BE RETAINED ON SITE FOR THE DURATION OF THE PROJECT.
3. THE DESIGN INFORMATION SHOWN ON THE DRAWINGS PROVIDES OVERALL DIMENSIONAL PARAMETERS AND DESCRIBES ELEMENTS TO BE CONSTRUCTED. THE CONTRACTOR SHALL ADJUST DIMENSIONS AND DETAILS AS REQUIRED TO FIT EXISTING CONDITIONS. THE ARCHITECT/ENGINEER SHALL BE NOTIFIED OF ALL PROPOSED MODIFICATIONS.
4. NO CHANGES TO THE INFORMATION SHOWN ON THE DRAWINGS SHALL BE MADE WITHOUT THE SPECIFIC WRITTEN APPROVAL OF THE ARCHITECT OR ENGINEER, AS APPLICABLE.
5. THE ARCHITECT SHALL BE NOTIFIED IMMEDIATELY OF ANY DISCREPANCIES ON THESE DOCUMENTS.
6. THE CONTRACTOR SHALL ADHERE TO THE REQUIREMENTS OF F.B.C. FOR SAFETY STANDARDS PERTAINING TO CONSTRUCTION PROCEDURES.
7. ALL GLAZING AND GLASS SHALL BE IMPACT RESISTANT GLASS. A FLORIDA APPROVED TESTING AGENCY MUST APPROVE AND LIST SUCH GLASS.
8. ALL EXTERIOR COMPONENTS SHALL HAVE FLORIDA APPROVAL NUMBERS.

## SHOP DRAWINGS

COPIES OF ALL SHOP DRAWINGS FOR STRUCTURAL OR LIFE SAFETY RELATED COMPONENTS SHALL BE SUBMITTED TO THE ARCHITECT & OWNER FOR APPROVAL. THE CONTRACTOR SHALL SUBMIT DETAILED FABRICATION AND INSTALLATION DRAWINGS AND PRODUCT LITERATURE FOR THE FOLLOWING ITEMS. ARCHITECT REVIEW OF SHOP DRAWING IS FOR COMPLIANCE OF THE PRODUCT WITH THE DESIGN CONCEPTS DELINEATED IN THESE DOCUMENTS. THE CONTRACTOR AND/OR PRODUCT MANUFACTURER SHALL BE RESPONSIBLE FOR THE ACCURACY AND PERFORMANCE OF THE PRODUCT AND ITS COORDINATION WITH THE OTHER TRADES.

1. STRUCTURAL STEEL
2. METAL STUD FRAMING
3. ROOF TRUSSES, LVL, & FIRE-ENGINEERED BEAMS
4. REINFORCING STEEL
5. CONCRETE DESIGN MIXES
6. WATERPROOF MEMBRANES
7. RAILINGS & HANDRAILS
8. ARCHITECTURAL PRE-CAST OR PRE-FORMED COLUMNS
9. APPLIED FOAM TRIM, WINDOW/DOOR HEADS, AND ARCHITECTURAL DETAILING
10. BATHROOM ACCESSORIES & MIRRORS
11. ALL FLOOR, WALL, AND CEILING FINISHES
12. CABINETRY
13. ELEVATORS
14. STAIRS AND HANDRAILS
15. ALL HEATING & VENTILATING EQUIPMENT
16. ELECTRICAL FIXTURES & EQUIPMENT
17. ALL PLUMBING FIXTURES
18. DOORS, WINDOWS, AND ALL HARDWARE
19. FIREPLACES
20. APPLIANCES

## PERFORMANCE STANDARDS

ALL MATERIALS, PRODUCTS AND THEIR INSTALLATION SHALL MEET THE PRODUCT APPROVAL OF AND BE INSTALLED IN ACCORDANCE WITH THE STANDARDS ESTABLISHED BY THE FOLLOWING AGENCIES, AS APPLICABLE:

- ASTM - AMERICAN SOCIETY OF TESTING MATERIALS  
 ACI - AMERICAN CONCRETE INSTITUTE  
 AFPA - AMERICAN FOREST & PAPER ASSOCIATION  
 AISC - AMERICAN INSTITUTE OF STEEL CONSTRUCTION  
 AIA - AMERICAN WOODWORK INSTITUTE  
 AWPB - AMERICAN WOOD PRESERVATIVES BUREAU  
 ANSI - AMERICAN NATIONAL STANDARDS INSTITUTE  
 AAMA - ARCHITECTURAL ALUMINUM MANUFACTURERS ASSOCIATION  
 FBC - FLORIDA BUILDING CODE  
 GA - GYPSUM ASSOCIATION  
 LSC - LIFE SAFETY CODE  
 NER - NATIONAL EVALUATION SERVICE INC  
 NFPA - NATIONAL FIRE PROTECTION ASSOCIATION  
 NDS - NATIONAL DESIGN SPECIFICATION FOR WOOD CONSTRUCTION  
 OSHA - OCCUPATIONAL SAFETY AND HEALTH ACT  
 SJI - STEEL JOIST INSTITUTE  
 TCA - TILE COUNCIL OF AMERICA  
 UL - UNDERWRITERS LABORATORIES

## BUILDING DESIGN DATA

APPLICABLE CODES  
 2020 FLORIDA BUILDING CODE BUILDING  
 2020 FLORIDA ACCESSIBILITY CODE  
 FLORIDA FIRE PREVENTION CODE

ARCHITECT  
 RUSSELL JOHNSON, ARCHITECT  
 P.O. BOX 1398  
 PANAMA CITY, FL 32401  
 (850) 630-4483  
 AR 0012593  
 RAJARARCH@MSN.COM

## INDEX OF DRAWINGS

- A100 COVER
- A101 FLOOR PLAN
- A102 ROOF PLAN
- ACCESSORIES
- A103 ELEVATIONS
- A104 BUILDING SECTION


RUSSELL JOHNSON ARCHITECT PL  
 ARCHITECTURE  
 850 630 4483  
 AR 0012593  
 rajarch@msn.com



DATE	REVISIONS	BY	DATE


PROJECT #

A NEW RESTROOM ON 7TH STREET  
 MEXICO BEACH  
 BAY COUNTY  
 FLORIDA

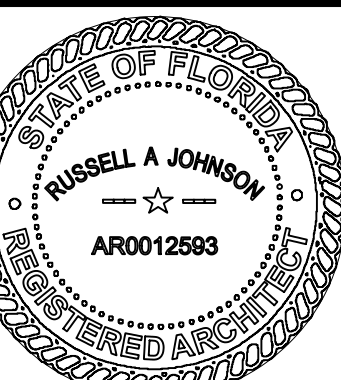

**LEGEND**

- ① ADA COMPLIANT RAMP - REFER TO CIVIL DRAWINGS
- ② COVERED ENTRY DECK - PROVIDE 6" W TREX DECKING  
COLOR AS SELECTED BY OWNER - ATTACH W/  
STAINLESS STEEL MARINE GRADE SCREWS
- ③ 2 X 6 SYP#2 WOOD FRAMED WALL - REFER TO  
REFER TO STRUCTURAL DRAWINGS FOR DETAILING  
PROVIDE R 13 INSULATION  
PROVIDE VAPOR BARRIER AND  
FIBERCEMENT SMOOTH PANELS INTERIOR  
FIBERCEMENT SMOOTH PANELS EXTERIOR
- ④ 8X8 FT COLUMN - REFER TO STRUCTURAL DRAWINGS  
FOR CONNECTION DETAILS - CHAMFER ALL EXPOSED EDGES
- ⑤ 42" H RAILINGS - CABLE RAILING SYSTEM BY "VIEWRAIL" OR APPROVED EQUAL  
CABLES TO BE 2205 GRADE COASTAL STAINLESS STEEL, MAX 3" SPACING  
SUPPORTS SHALL BE STAINLESS STEEL 2205 SERIES, SIDE MOUNT  
ALL HARDWARE SHALL BE STAINLESS STEEL  
HANDRAIL SHALL BE 2" X 1" 2205 STAINLESS STEEL "VIEWRAIL" PRODUCT.  
POST SPACING SHALL BE PER MANUFACTURER'S REQUIREMENTS TO MEET  
FLORIDA BUILDING CODE 2020.
- ⑥ 3'-0" W X 8'-0" H FIBERGLASS DOOR - IMPACT RATED  
WITH FLORIDA PRODUCT APPROVAL NUMBER  
"MAHOGANY PLANK" - POWDER COATED FRAME, BLACK  
COMPOSITE FRAME MEETING CODE REQUIREMENTS ARE  
ACCEPTABLE. PROVIDE SS CLOSER, SS HINGES, SS COMPLIANT  
LEVER LOCKSET (LOCKABLE FROM THE INTERIOR), WEATHER  
SEAL AND ALUMINUM ADA COMPLIANT THRESHOLD.  
ALL HARDWARE SHALL BE HEAVY DUTY COMMERCIAL  
GRADE AND SHALL BE APPROVED BY OWNER PRIOR  
TO BIDDING/PURCHASING.
- ⑦ ALUMINUM LOUVERS W/ BIRD SCREEN, BLACK COASTAL RATED FINISH -  
PROVIDE 1 X 4 AZTEK OR EQUAL PAINTED TRIM TO MATCH DOOR  
COORDINATE W/ MECHANICAL DRAWINGS
- ⑧ HARDIE ARCHITECTURAL PANELS - REFER TO ELEVATIONS  
- PAINTED WHITE
- ⑨ PLUMBING FIXTURES - ADA COMPLIANT - REFER TO A105  
SUBMIT SHOP DRAWINGS TO OWNER FOR APPROVAL  
PRIOR TO PURCHASE
- ⑩ CONCRETE FLOOR - SEALED W/ EPOXY COATING  
TURN EPOXY COATING 8" AT WALLS, PROVIDE COVE BASE  
OR APPROVED EQUAL
- ⑪ EXPOSED BEAM ENDS - TAPER AS INDICATED
- ⑫ METAL ROOFING ON STRUCTURAL DECKING PER STRUCTURAL DRAWINGS.  
ON SYNTHETIC CODE APPROVED UNDERLAYMENT. W/ METAL DRIP EDGE MATCHING ROOFING  
PROVIDE A METAL FASCIA MATCHING ROOFING AS REQUIRED TO CONCEAL ROOF JOISTS.  
ROOFING TO BE ALUMINUM STANDING SEAM, CONCEALED FASTENER  
WITH A FLORIDA PRODUCT APPROVAL NUMBER, ATTACHED  
PER THE MANUFACTURER'S REQUIREMENTS TO MEET WIND LOADS.  
ROOFING SHALL BE A COMPLETE ASSEMBLY WITH ALL FLASHINGS, ETC  
ROOFING FINISH SHALL BE FLUROTHANE COASTAL COATING  
PREMIUM FLUOROPOLYMER (PVDF) SYSTEM BY VALSPAR  
WITH A MINIMUM COASTAL WARRANTY 20/20/20  
OR APPROVED EQUAL
- ⑬ PROVIDE S.S. SHOWER CONTROLS  
HIDDEN WITHIN AN 8FT TALL "COLUMN"  
CONSTRUCTED W/ (4) 2X6 FT VERTICALS  
ENCASED W/ PAINTED HARDIE TRIM
- ⑭ (2) ROWS 2 X 6 WOOD FRAMED WALL - PROVIDE SMOOTH  
FIBER CEMENT PANELS FOR INTERIOR SURFACES  
OVER 1/2" FT PLYWOOD SHEATHING  
PROVIDE 1 X 4 AZTEK FLOOR BASE  
PROVIDE (2) ROWS OF 4" SOUND INSULATION
- ⑮ OUTDOOR SHOWER - ADA COMPLIANT  
PROVIDE UNDER DECK DRAIN SYSTEM  
TO COLLECT WATER TO FLOOR DRAIN  
COORDINATE W/ PLUMBING DRAWINGS

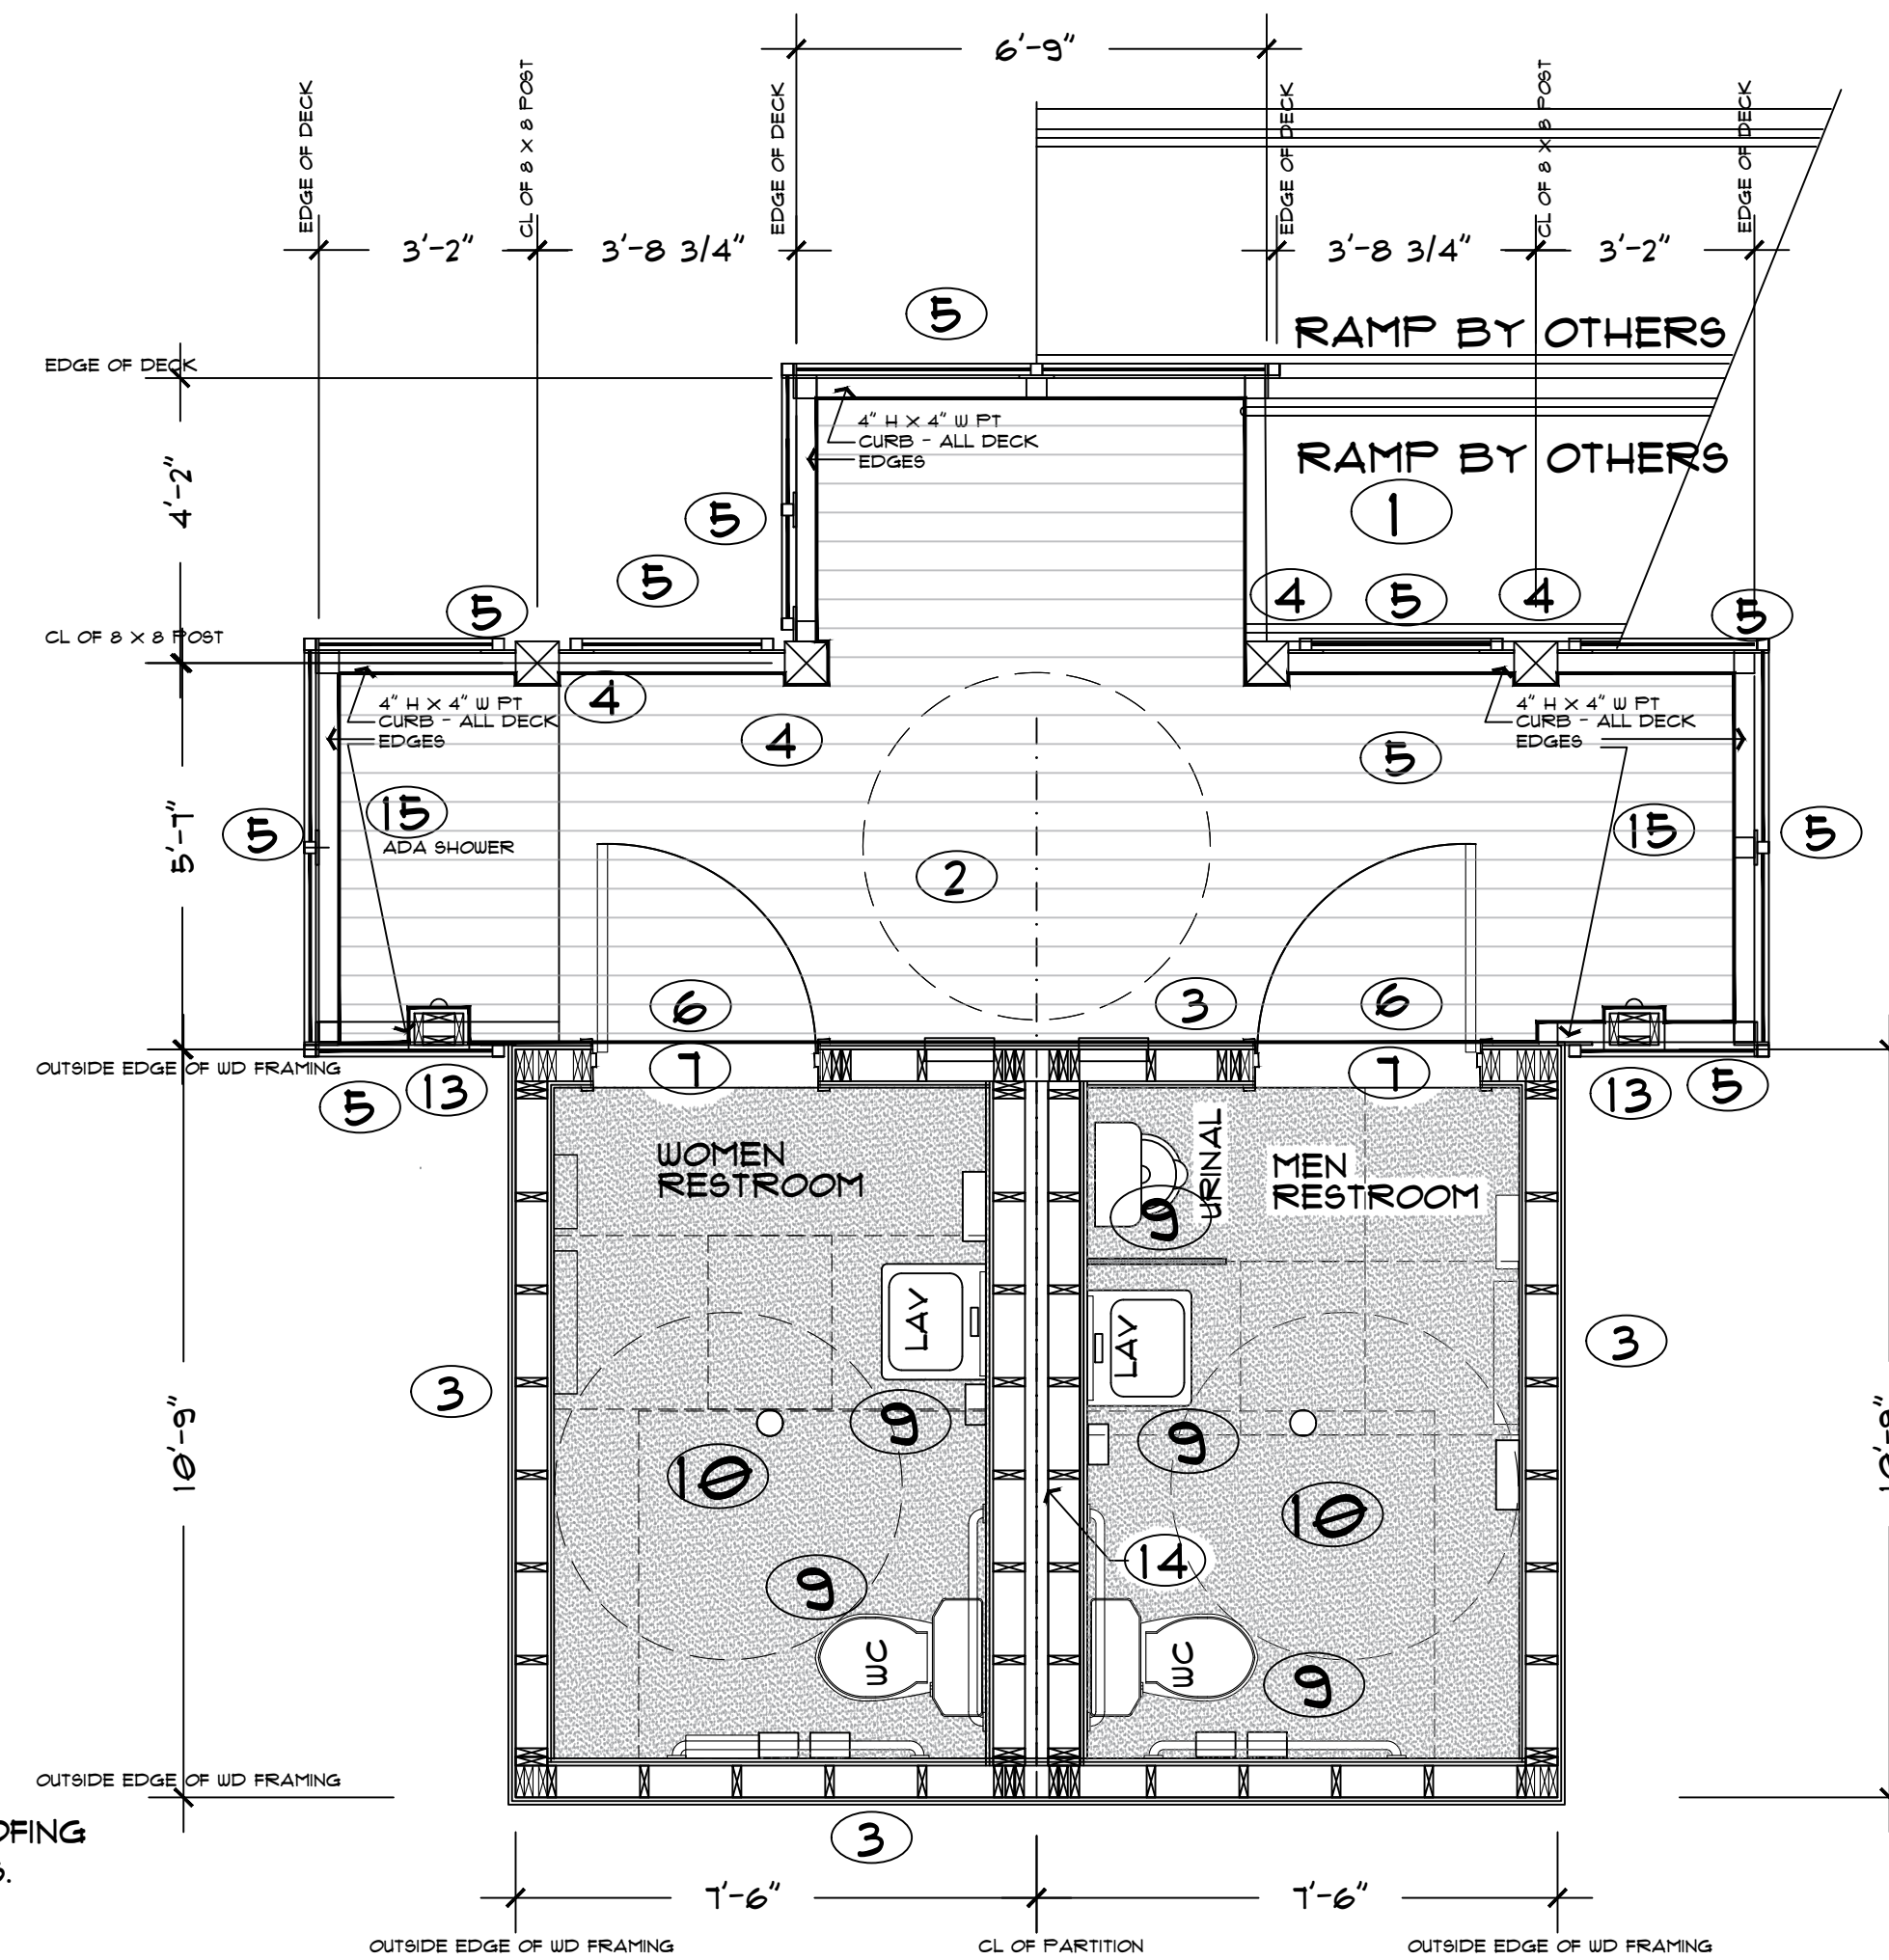

NOTE: PROVIDE ROOM IDENTIFICATION SIGNS MEETING  
ADA & FBC 2020 REQUIREMENTS. SUBMIT FULL SHOP  
DRAWINGS TO OWNER FOR APPROVAL.

**FLOOR PLAN**



SCALE: 3/8" = 1'-0"

RUSSELL JOHNSON ARCHITECT PL  
ARCHITECTURE  
850 630 4483  
AR 00012593  
rajarch@msn.com



RESTROOMS  
7TH STREET

A - 101

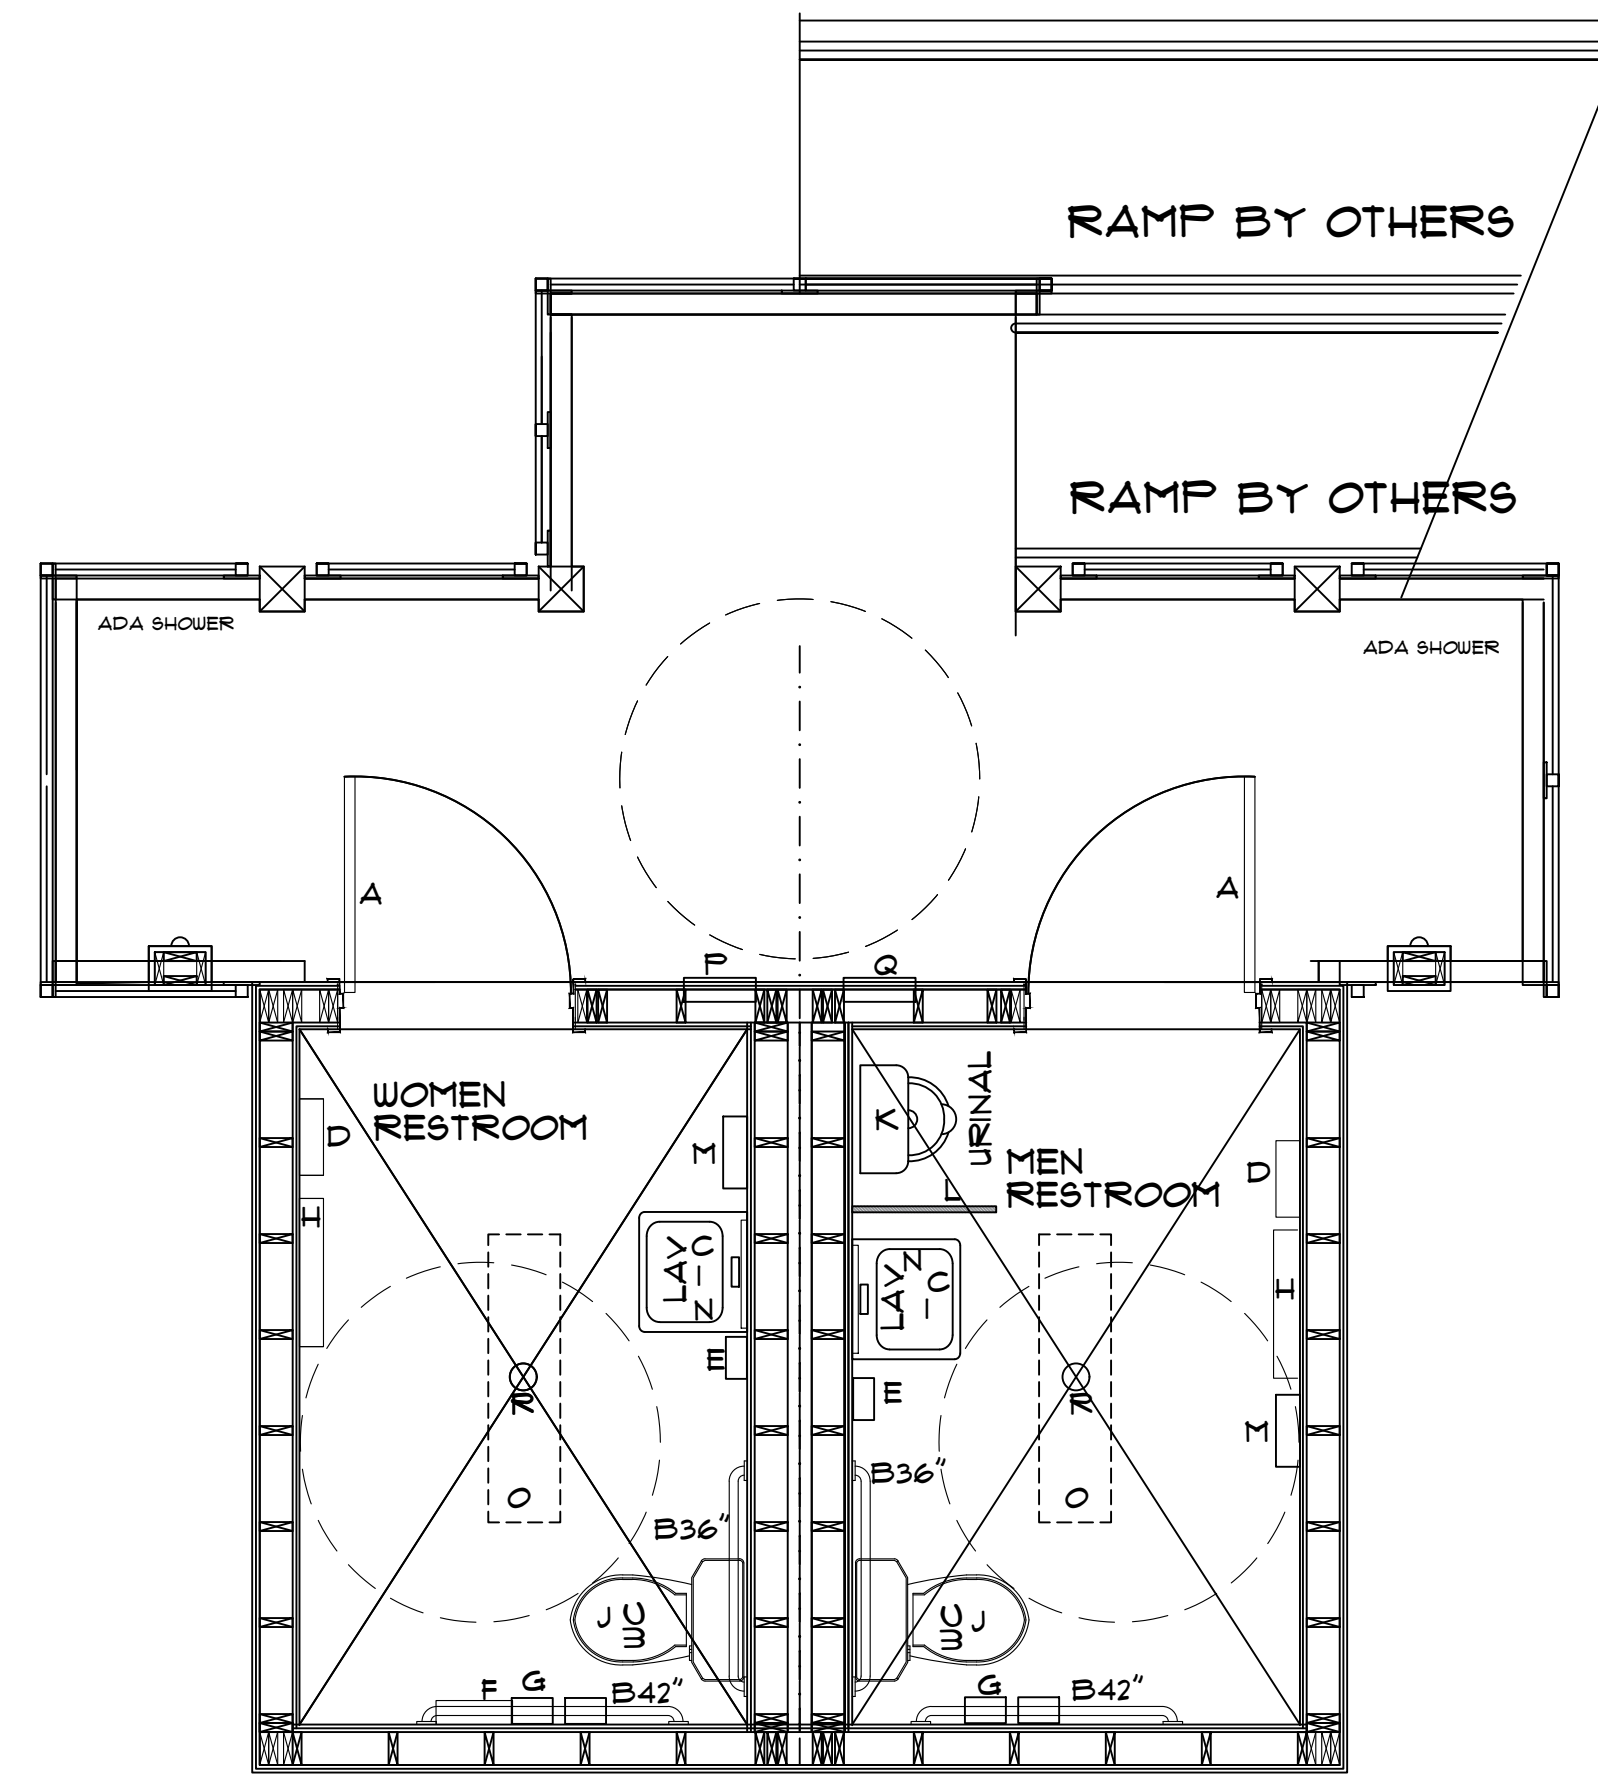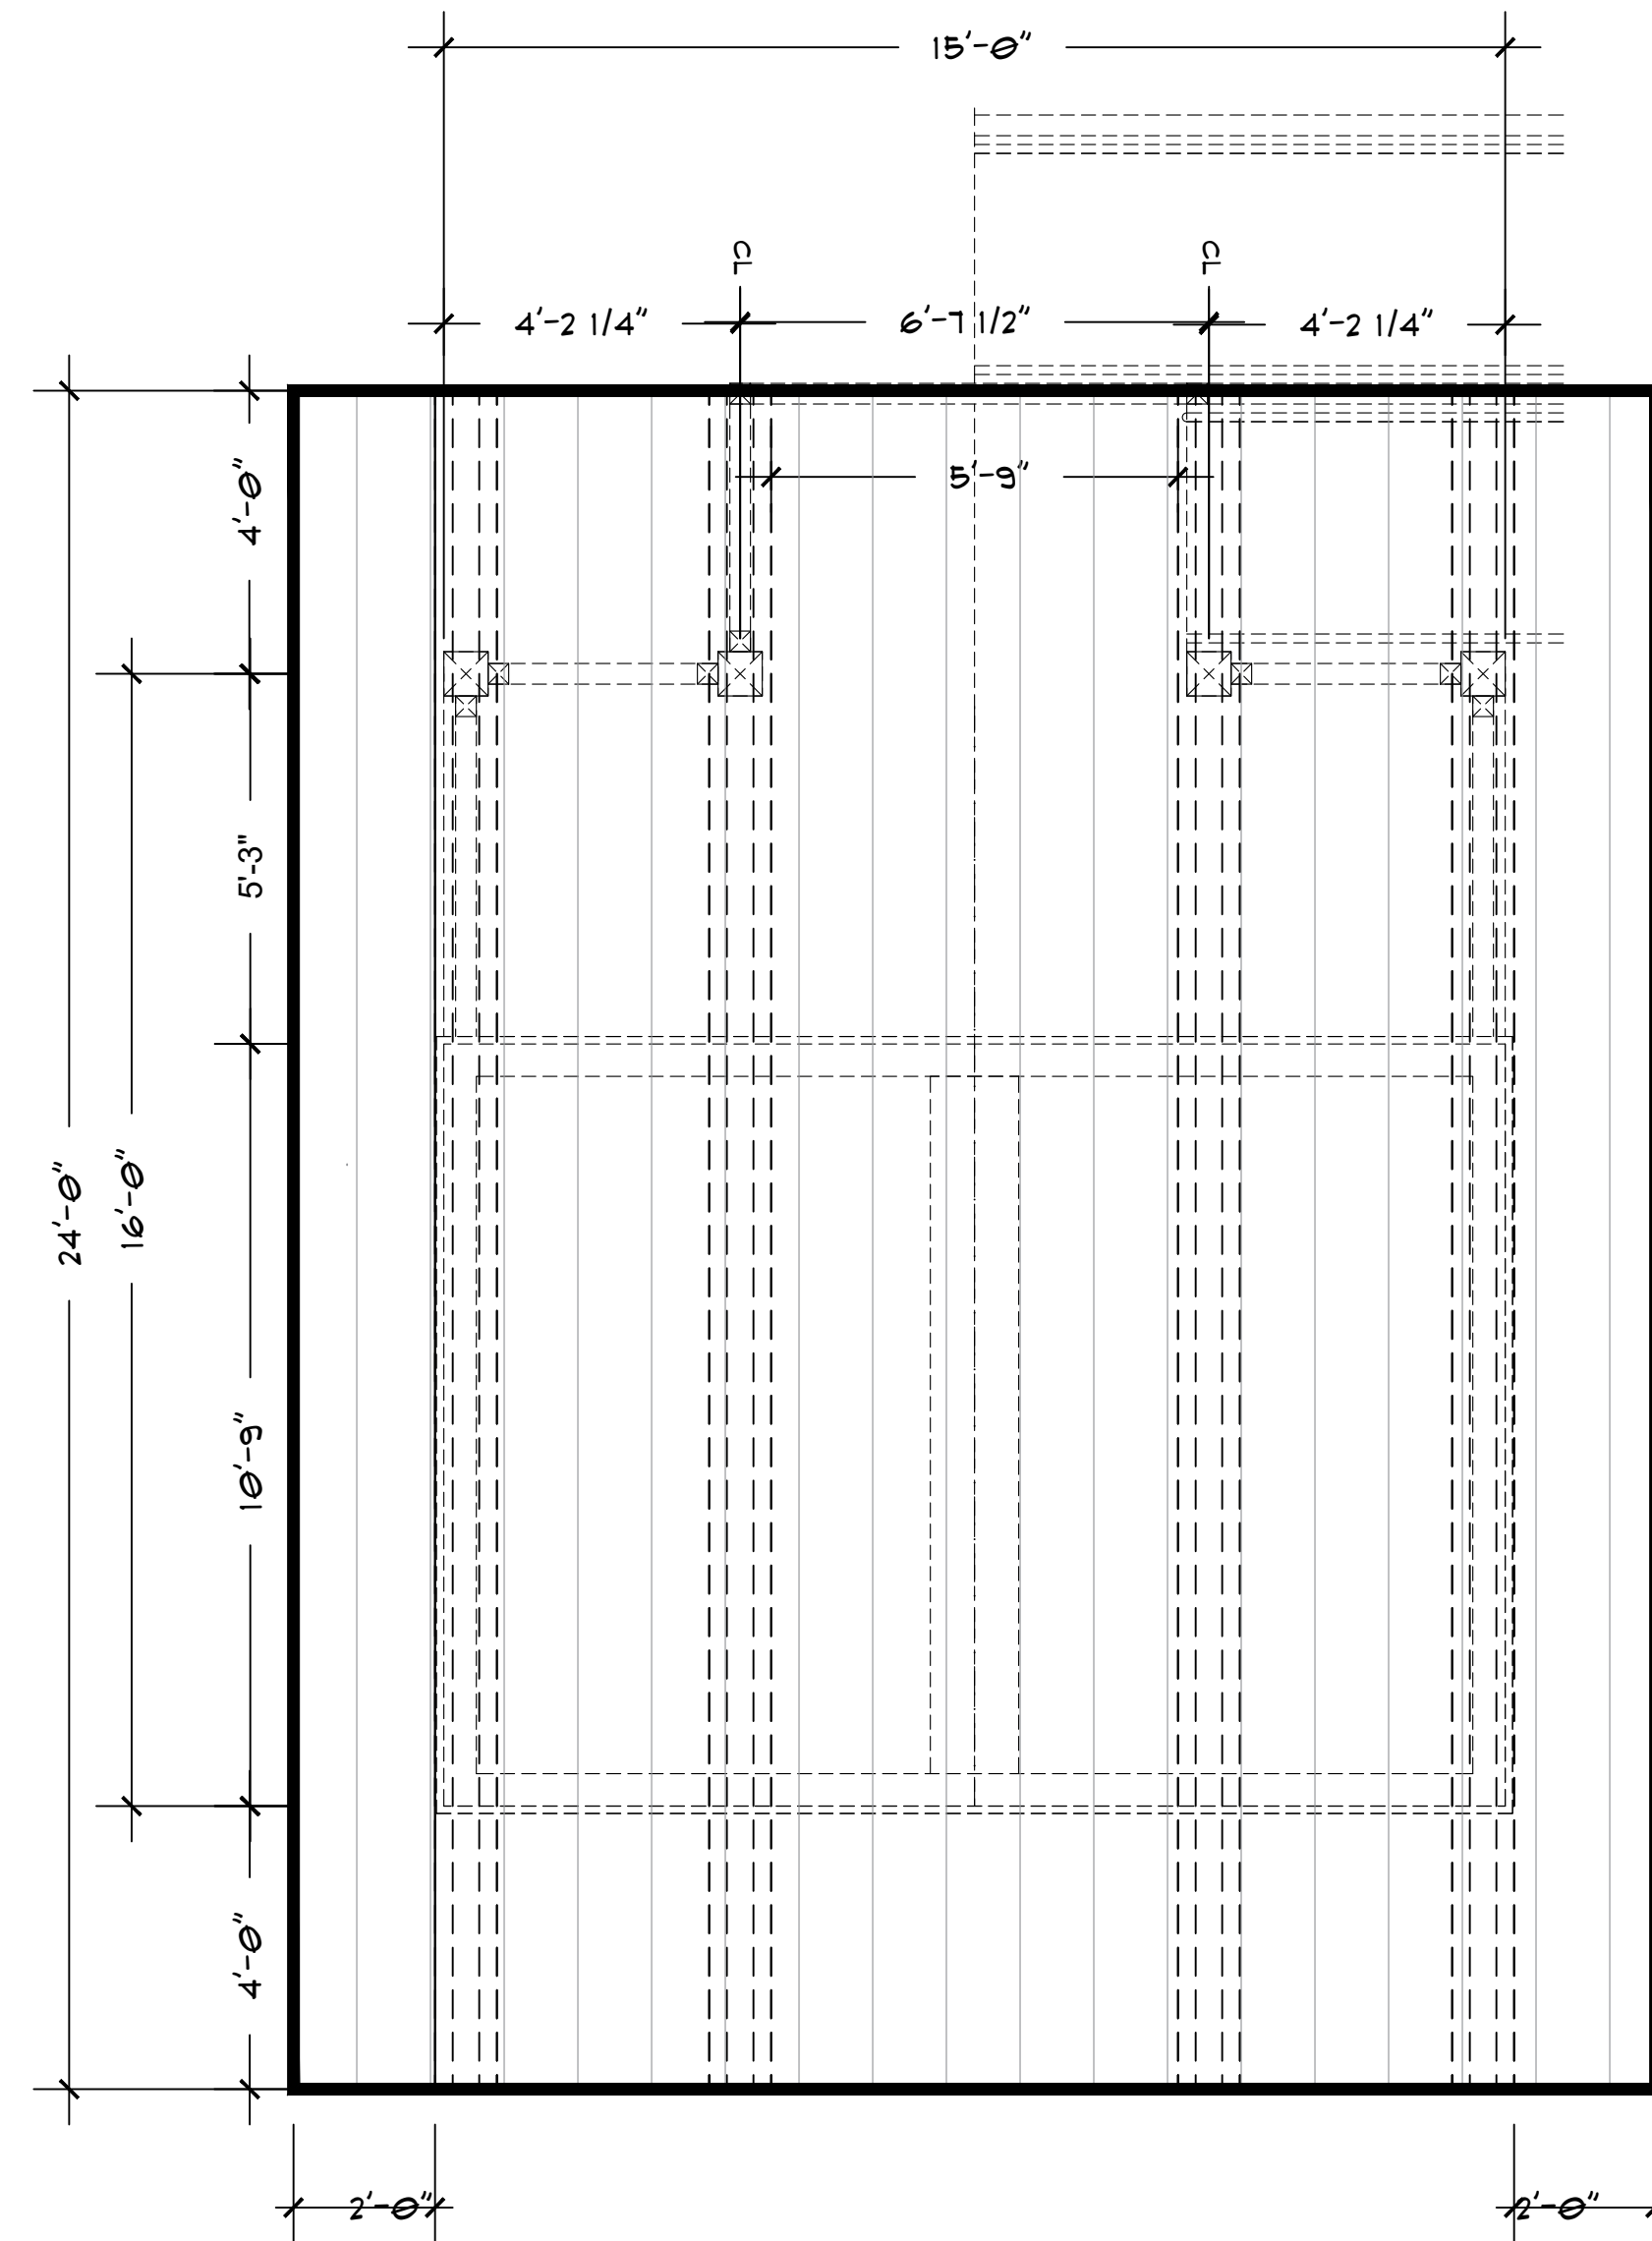

BATHROOM ACCESSORIES - FLOOR PLAN

BATHROOM ACCESSORY PRODUCT SELECTION SCHEDULE

NOTE: Specified products listed are for design intent/quality control, approved equals are accepted as approved by owner. Submit complete shop drawings and specs for owner review and approval. All accessories shall be ADA compliant.

- A** COAT HOOK Bobrick B-6707 satin finished stainless steel finished single utility/coat hook.
- B** GB; Bobrick B-6806.99 series peened satin stainless steel finished grab bars for accessible toilet size 42" L side wall, 36" L back wall
- C** MIR FR SH, Bobrick B-292 1830 series welded satin stainless steel finish framed mirror with 5" shelf, 18" x 30".
- D** Bobrick 316 satin stainless steel finished surface mounted waste receptacle
- E** SDISP, Bobrick B-2111 classic series surface mounted soap dispensers with satin stainless steel finish.
- F** SND, Bobrick B-270 contura series surface mounted satin stainless steel finish sanitary napkin dispenser.
- G** TPH; Bobrick B-6867 classic series surface mounted satin stainless steel finish two roll toilet paper holder.
- H** ADA COMPLIANT American Specialties, Inc 10-9014 Plastic Surface Mount Horizontal baby station
- I** ADA COMPLIANT LAV ( exposed piping shall be insulated per ada requirements) w/ faucet.....
- J** ADA COMPLIANT WATER CLOSET - KOHLER Persuade Curv Comfort Height or owner approved equal.
- K** ADA COMPLIANT WALL MOUNTED URINAL - kohler Steward Hybrid K-5244-ET-0 or owner approved equal
- L** 24" w x 42" H WALL MOUNTED PHENOLIC PARTITION W/ SS MOUNTING BRACKETS
- M** WALL MOUNTED HAND DRYER - EXCEL THINAIR HAND DRYERMODEL NO. TA-SB w/ white ABS cover, ..... wall mounted, ADA COMPLIANT
- N** Wall mounted tankless water heater - locate beneath LAV - refer to mep drawings
- O** SURFACE MOUNTED light fixture - refer to electrical drawings
- P** Lockable Electrical Panel - refer to electrical drawings
- Q** Recessed Fire extinguisher in ss cabinet
- R** Floor drain - slope floor to drain 1/8" / ft. Coordinate w/ plumbing drawings

NOTE: REFER TO MECH & ELEC DRAWINGS FOR WATER HEATERS, HEATERS, EXHAUST FANS, ALL LIGHT FIXTURES, ETC

METAL ROOFING ON STRUCTURAL DECKING PER STRUCTURAL DRAWINGS. ON SYNTHETIC CODE APPROVED UNDERLAYMENT. W/ METAL DRIP EDGE MATCHING ROOFING PROVIDE A METAL FASCIA MATCHING ROOFING AS REQUIRED TO CONCEAL ROOF JOISTS. ROOFING TO BE ALUMINUM STANDING SEAM, CONCEALED FASTENER WITH A FLORIDA PRODUCT APPROVAL NUMBER, ATTACHED PER THE MANUFACTURER'S REQUIREMENTS TO MEET WIND LOADS. ROOFING SHALL BE A COMPLETE ASSEMBLY WITH ALL FLASHINGS, ETC ROOFING FINISH SHALL BE FLUROTHANE COASTAL COATING PREMIUM FLUOROPOLYMER (PVDF) SYSTEM BY VALSPAR WITH A MINIMUM COASTAL WARRANTY 20/20/20 OR APPROVED EQUAL


ACCESSORIES  
ROOF PLAN

SCALE: 3/8" = 1'-0"


RUSSELL JOHNSON ARCHITECT PL  
ARCHITECTURE  
850 630 4483  
AR 00012593  
rajarch@msn.com




RESTROOMS  
7TH STREET

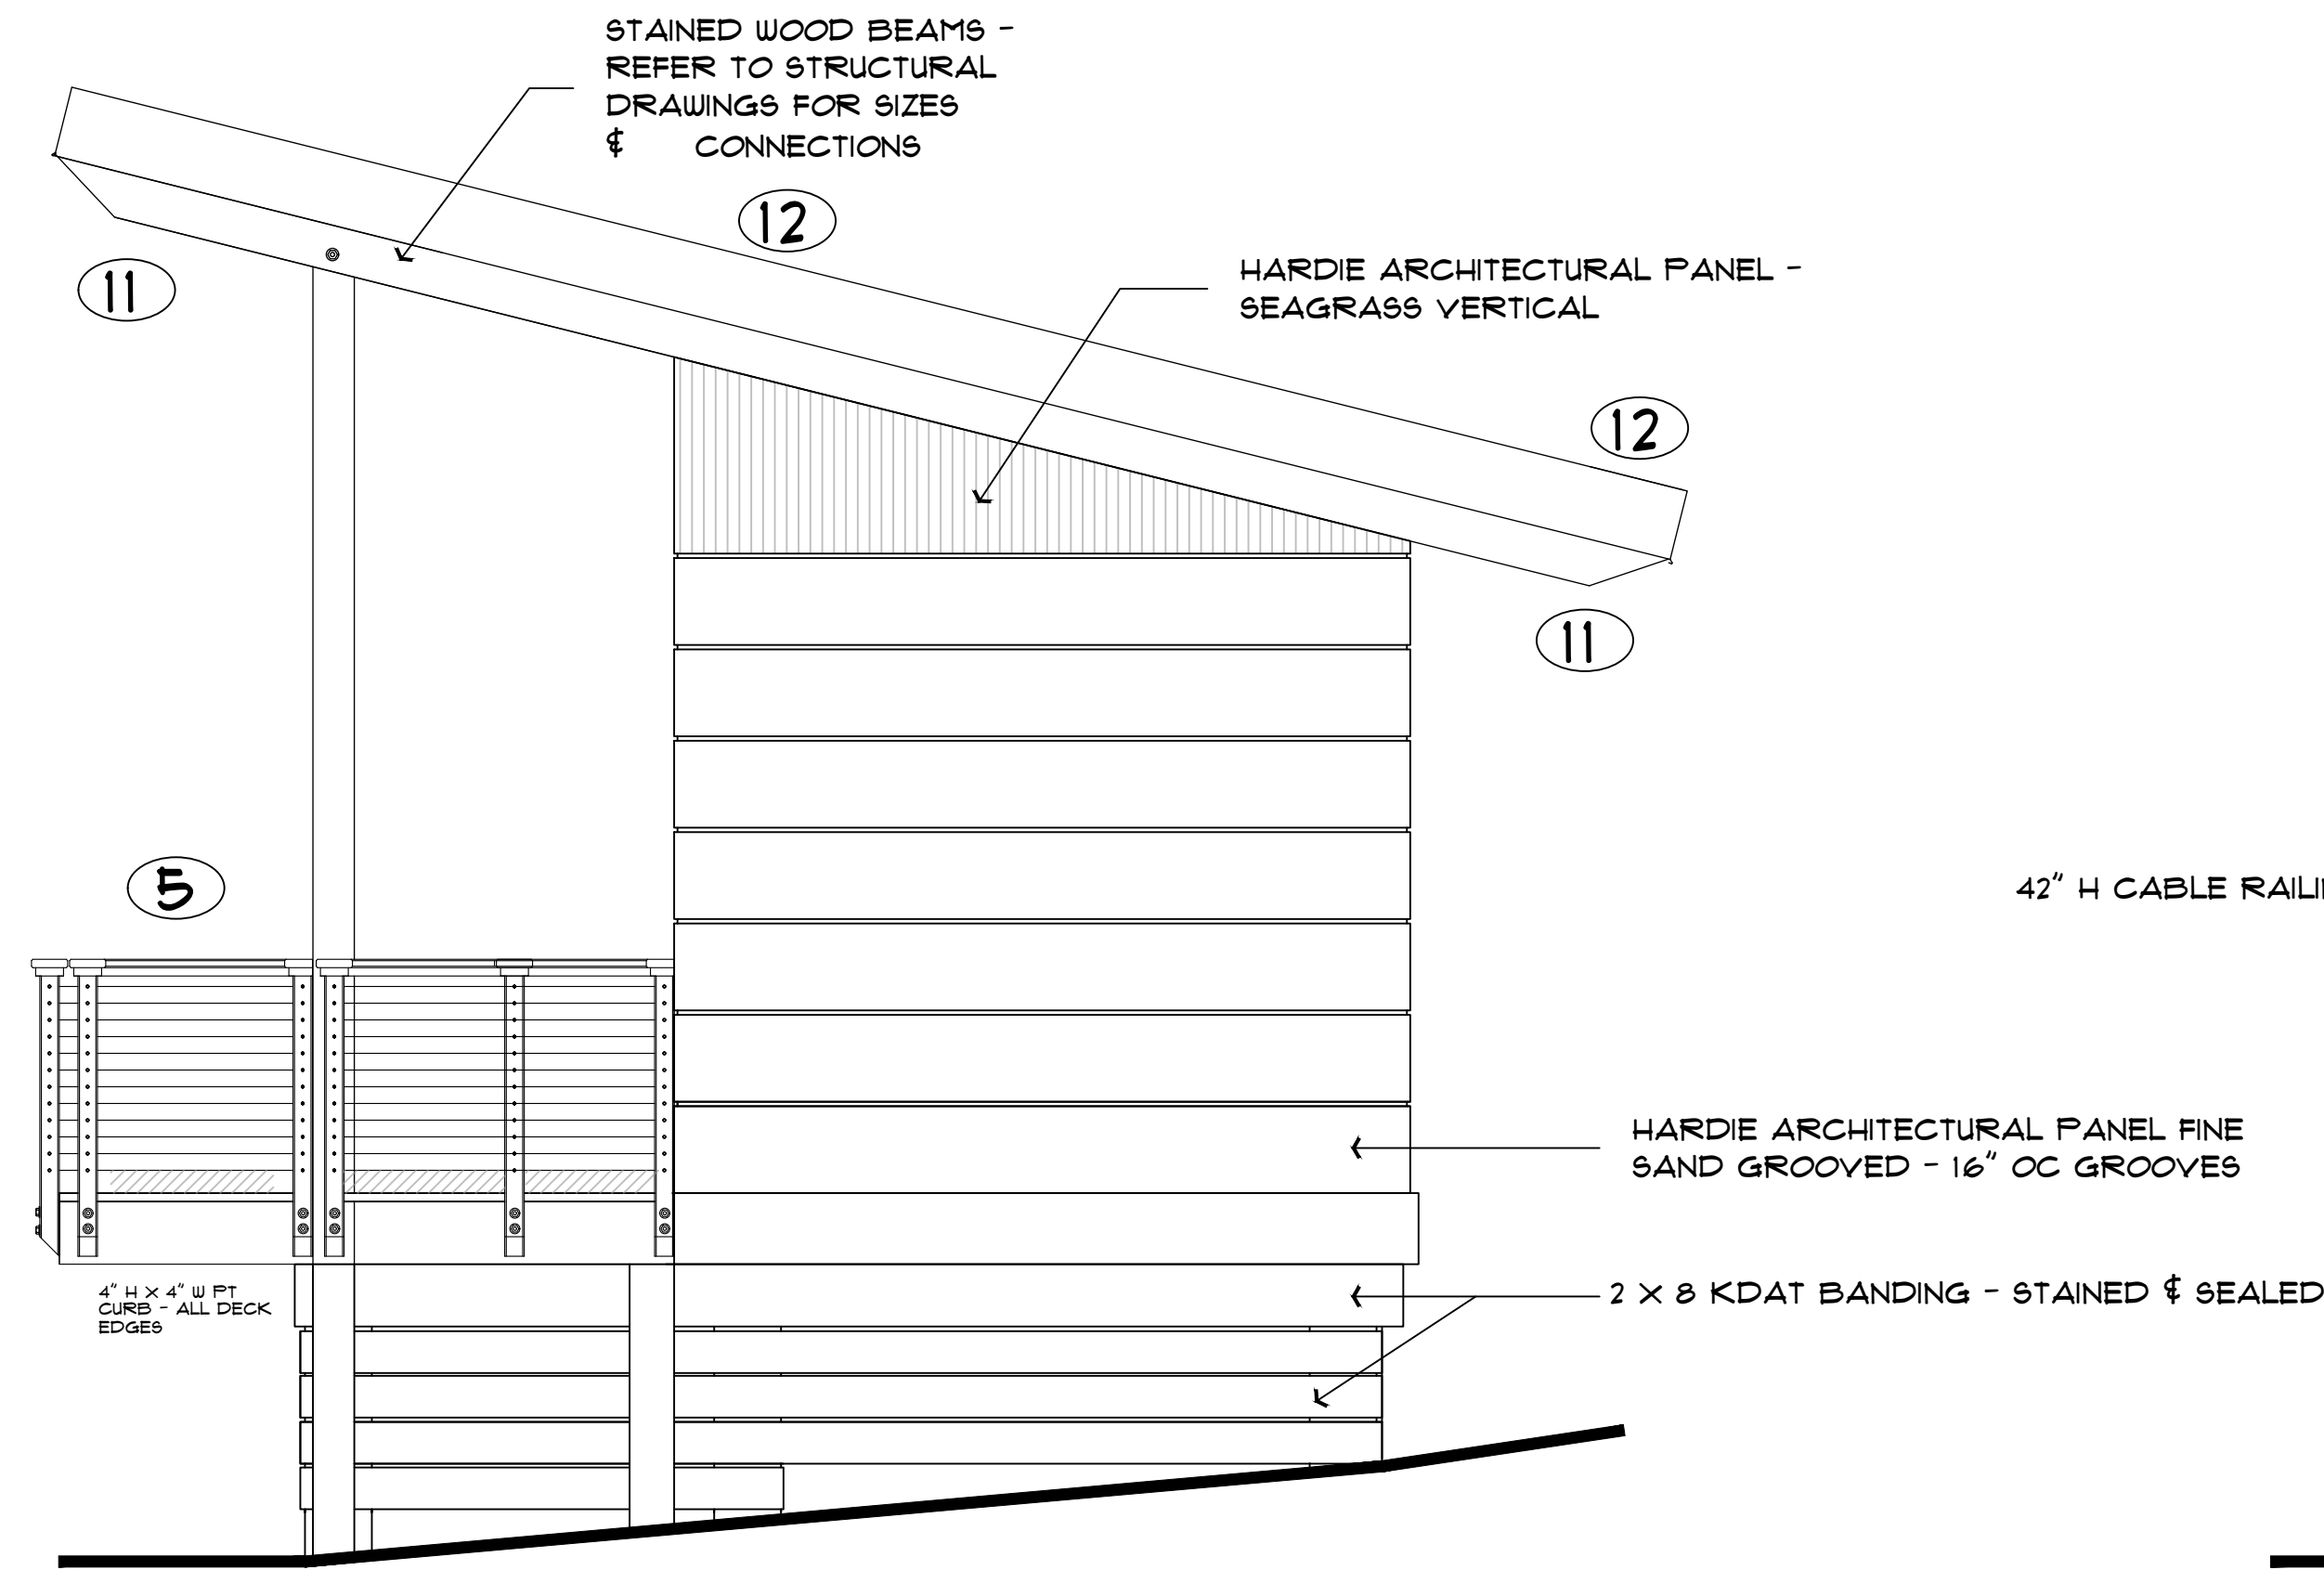


**RIGHT SIDE ELEVATION**  
 NOTE: RAMP NOT SHOWN FOR CLARITY  
 REFER TO CIVIL DRAWINGS FOR RAMP DESIGN

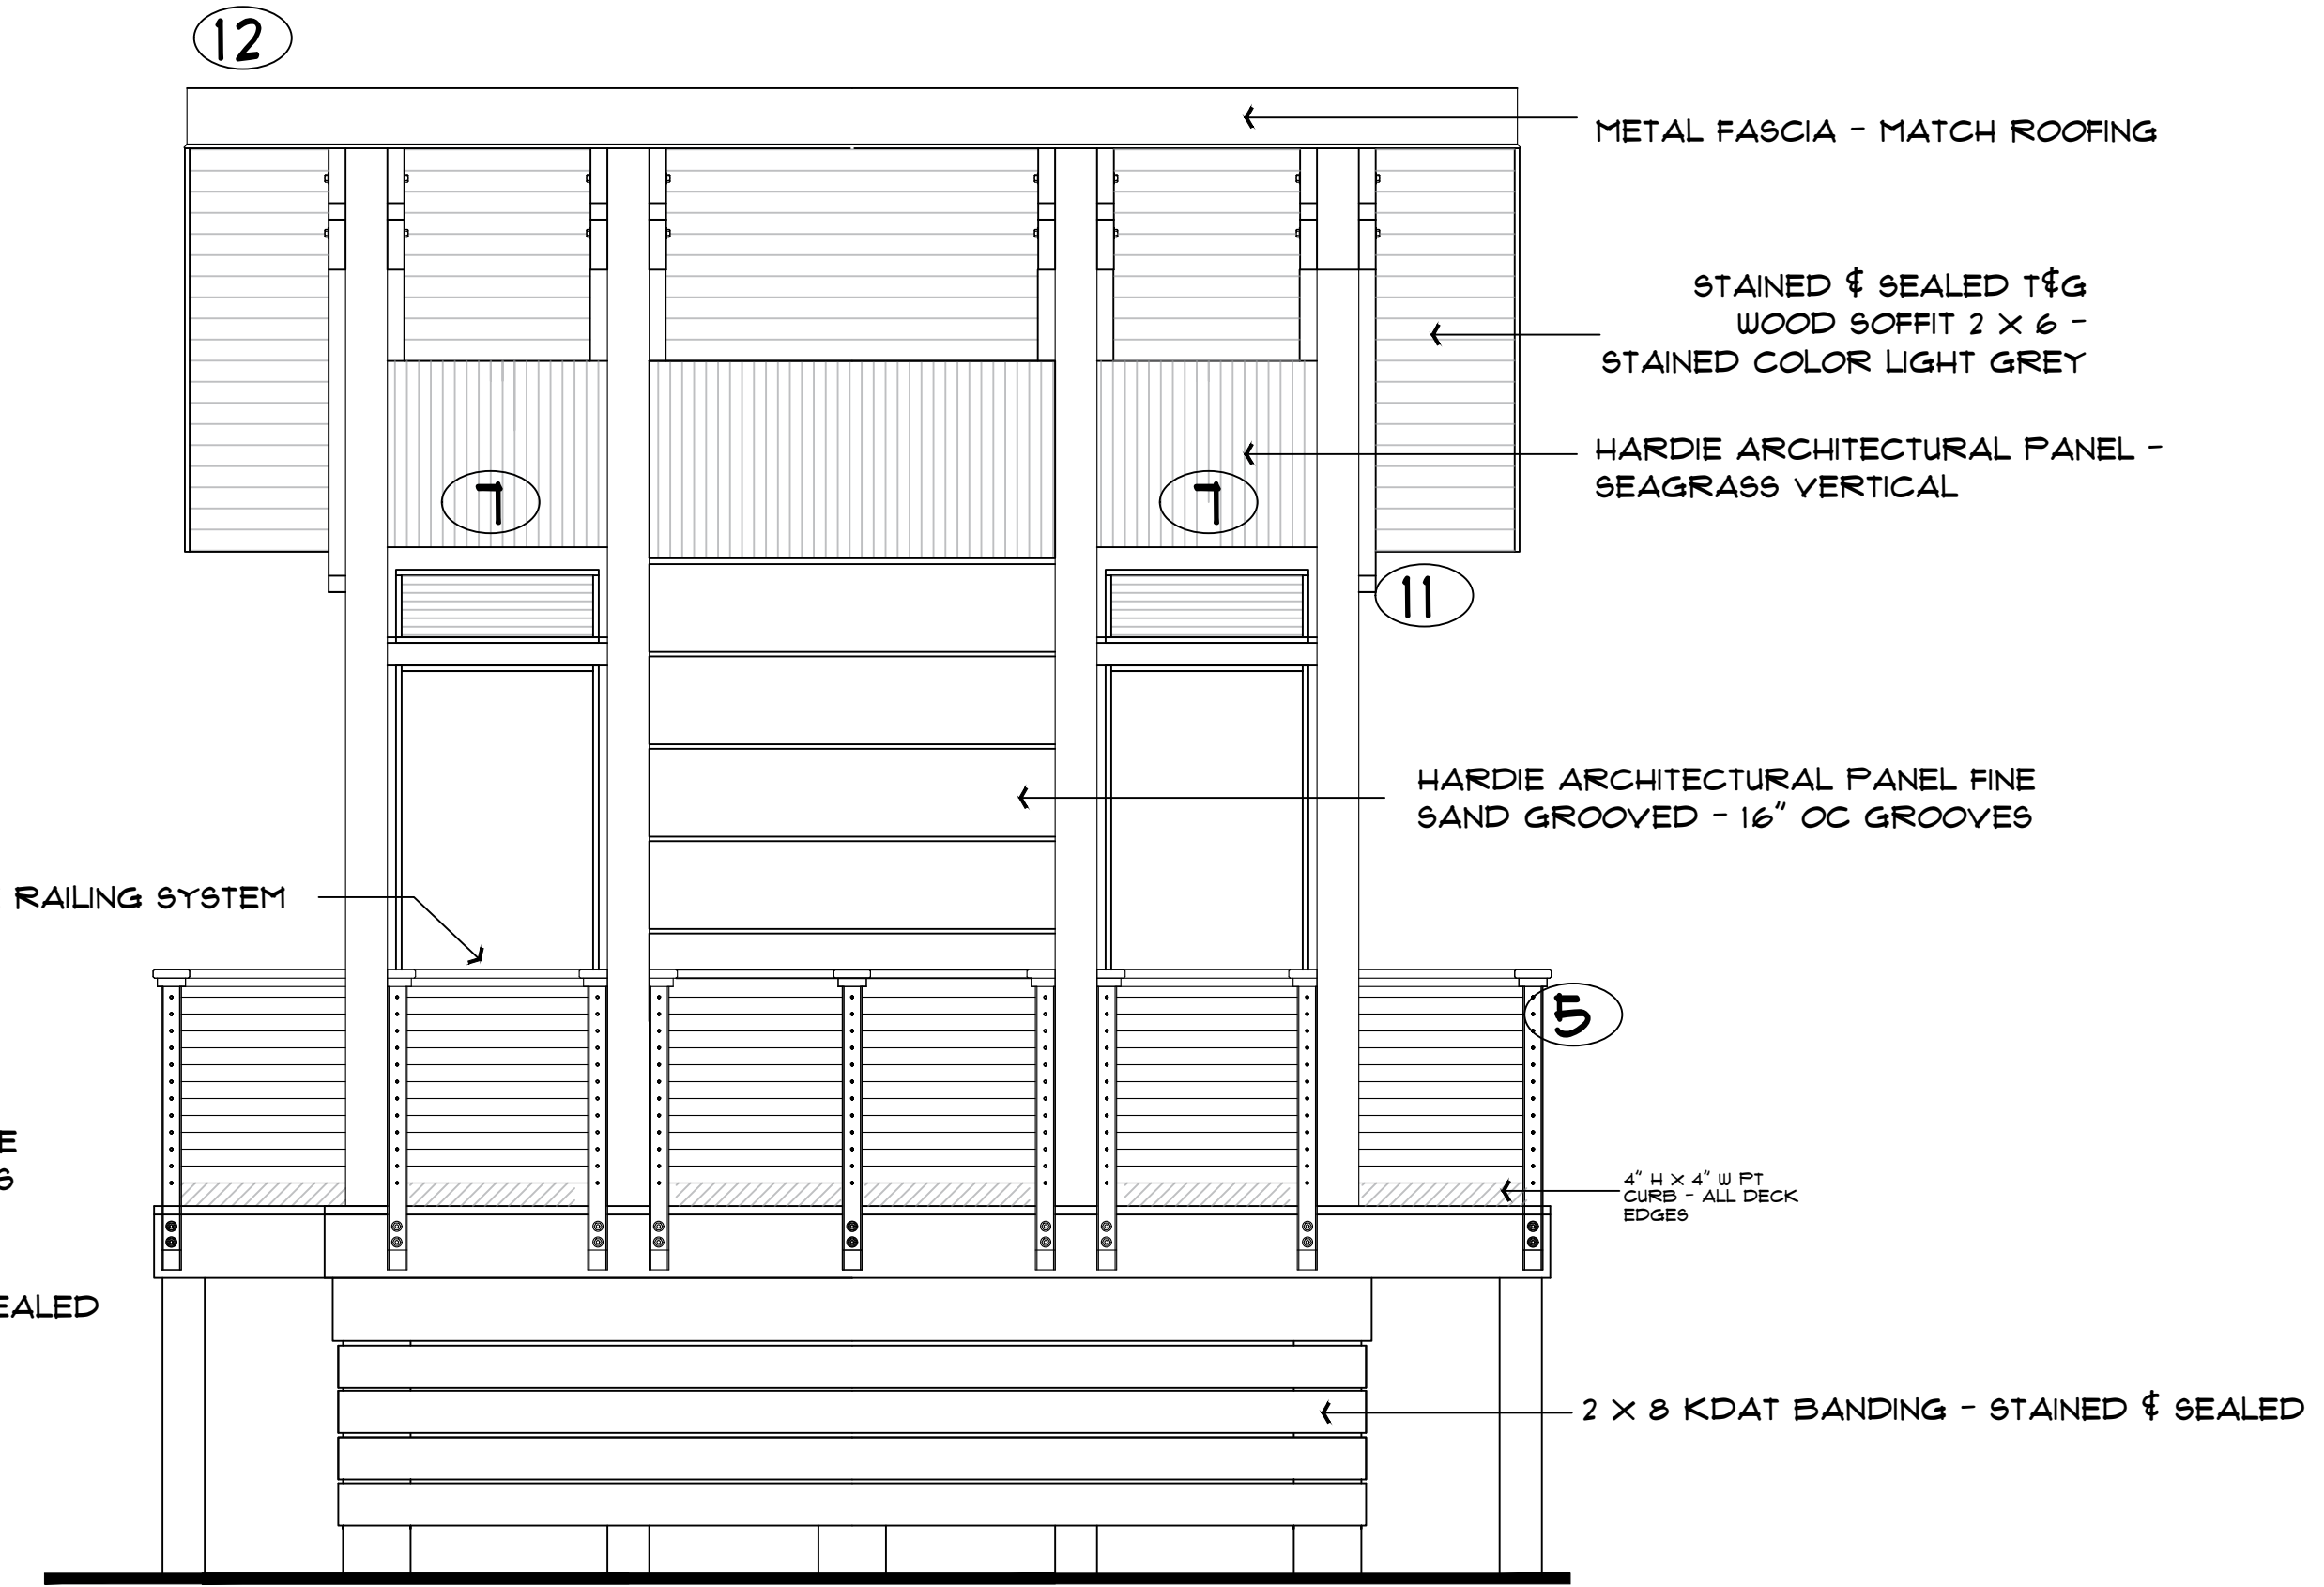

**FRONT ELEVATION**  
 NOTE: RAMP NOT SHOWN FOR CLARITY  
 REFER TO CIVIL DRAWINGS FOR RAMP DESIGN

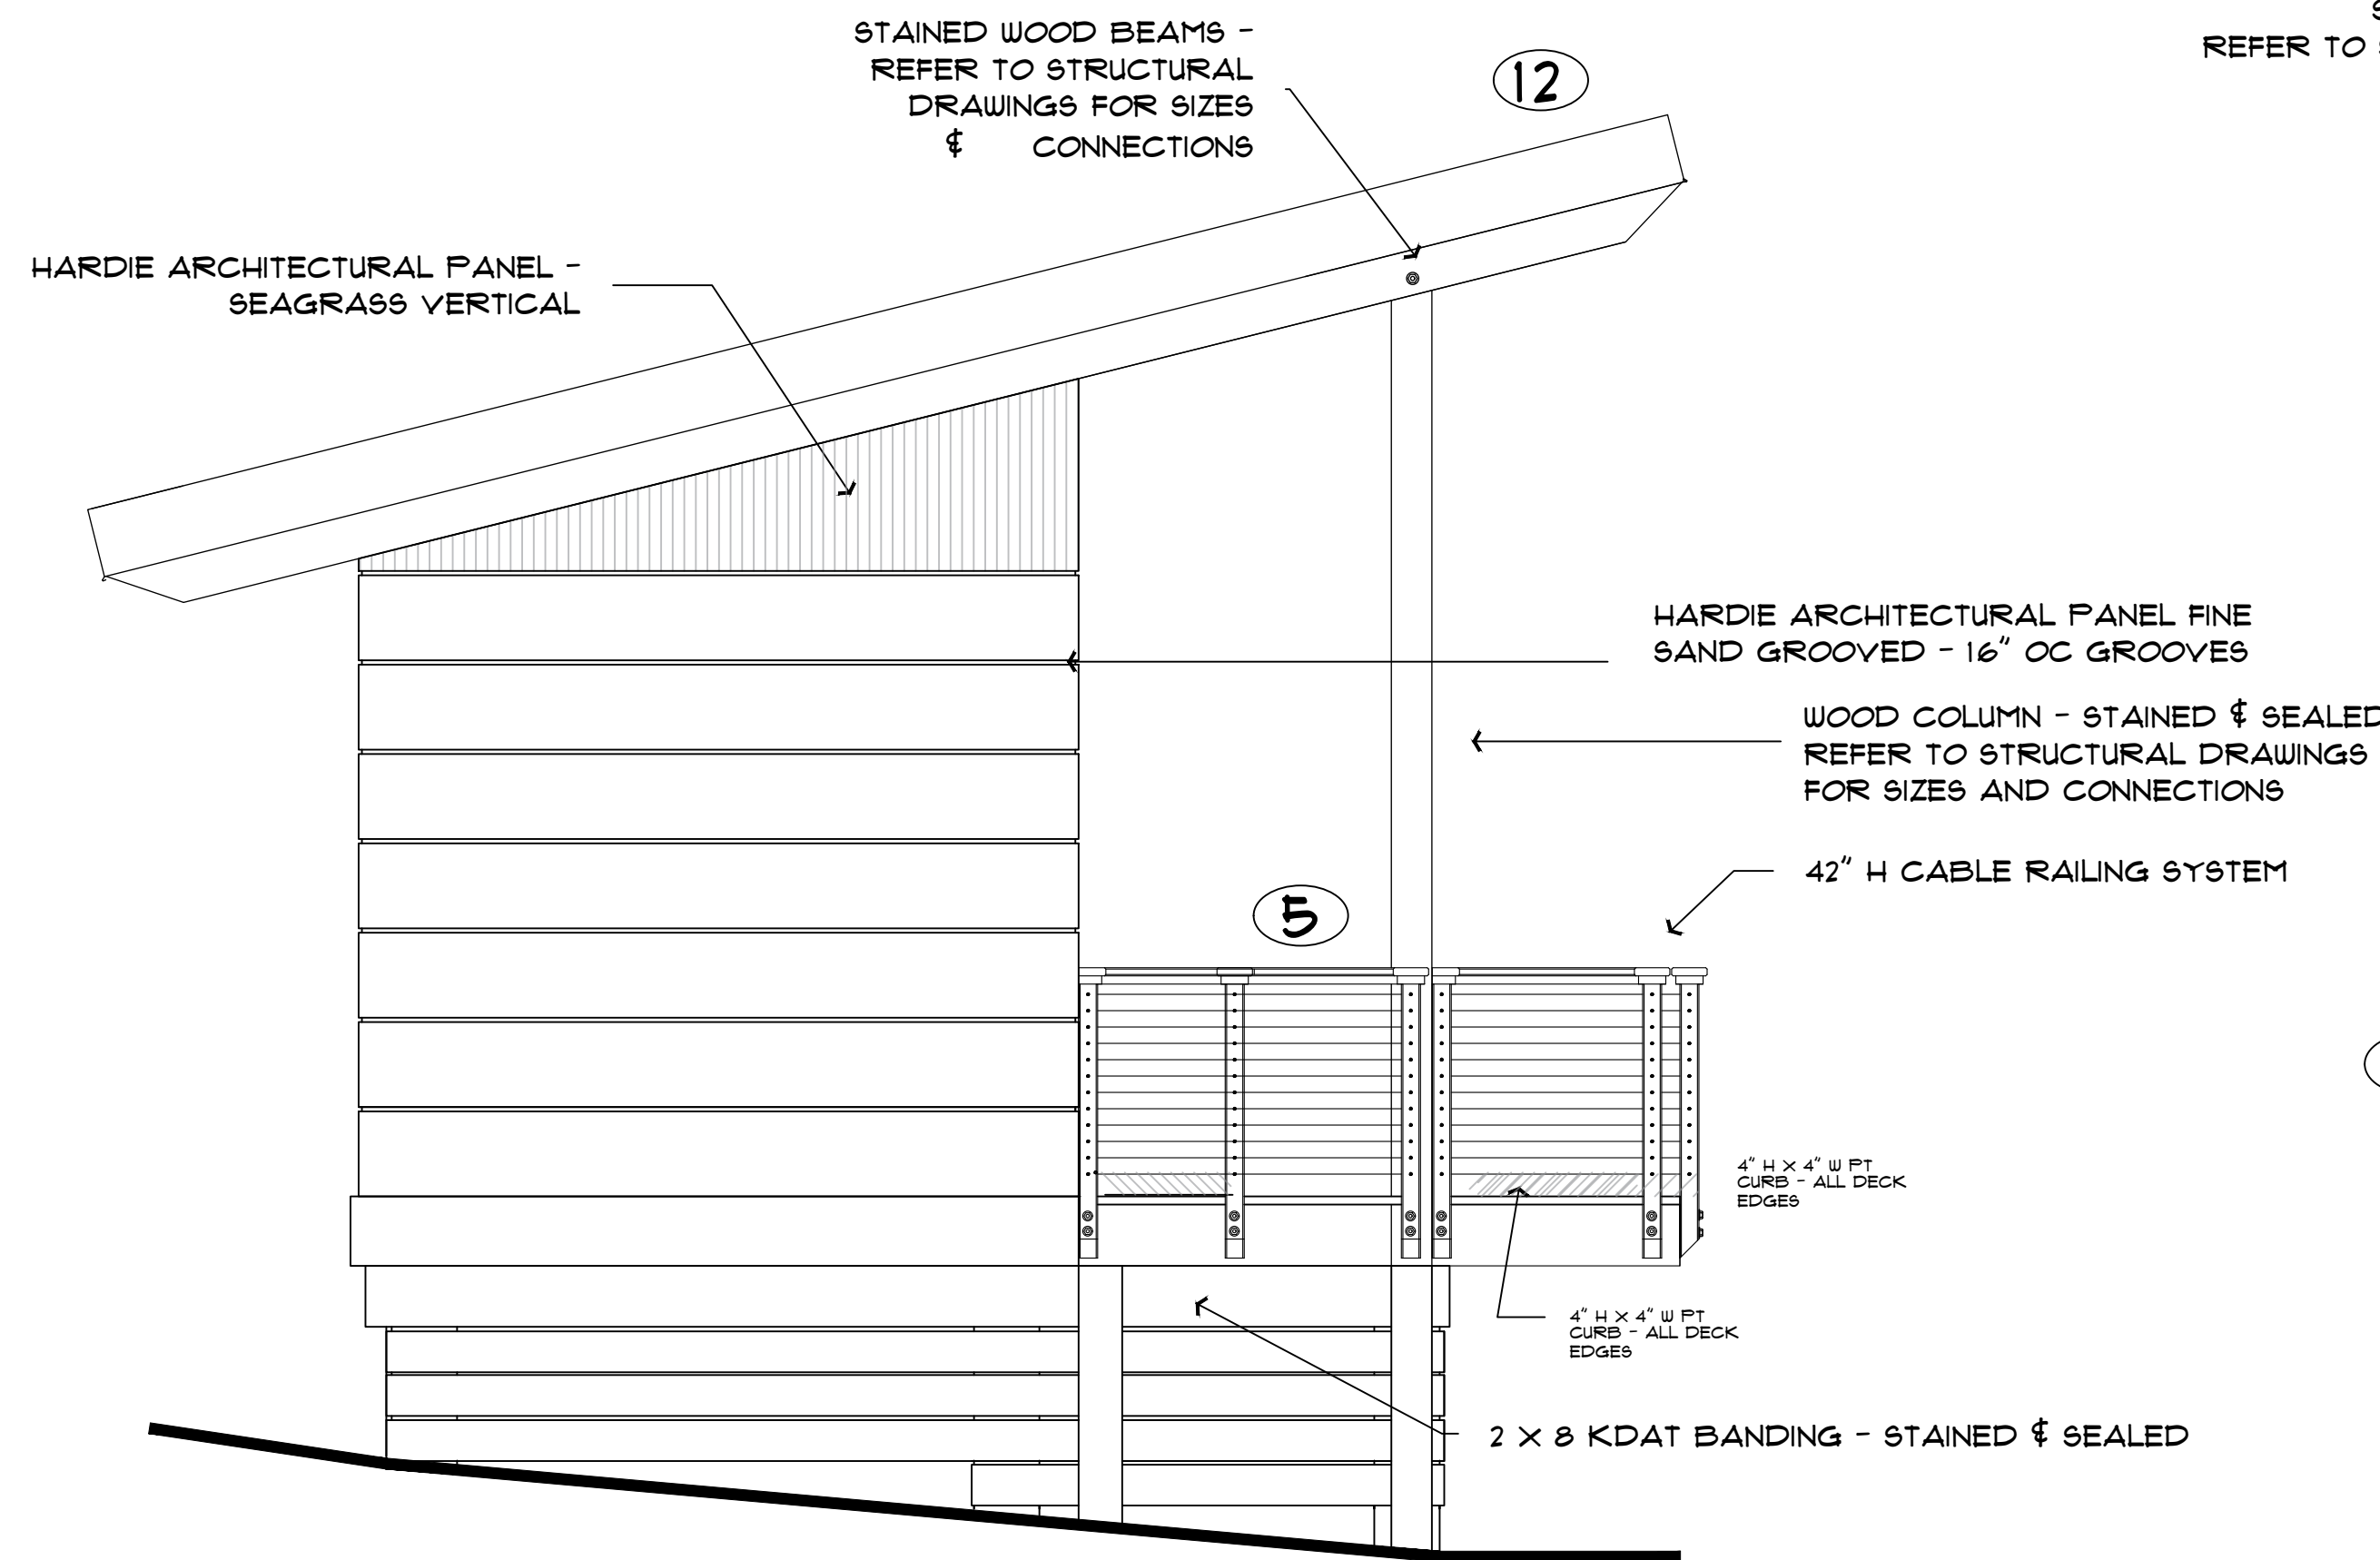


**LEFT SIDE ELEVATION**  
 NOTE: RAMP NOT SHOWN FOR CLARITY  
 REFER TO CIVIL DRAWINGS FOR RAMP DESIGN

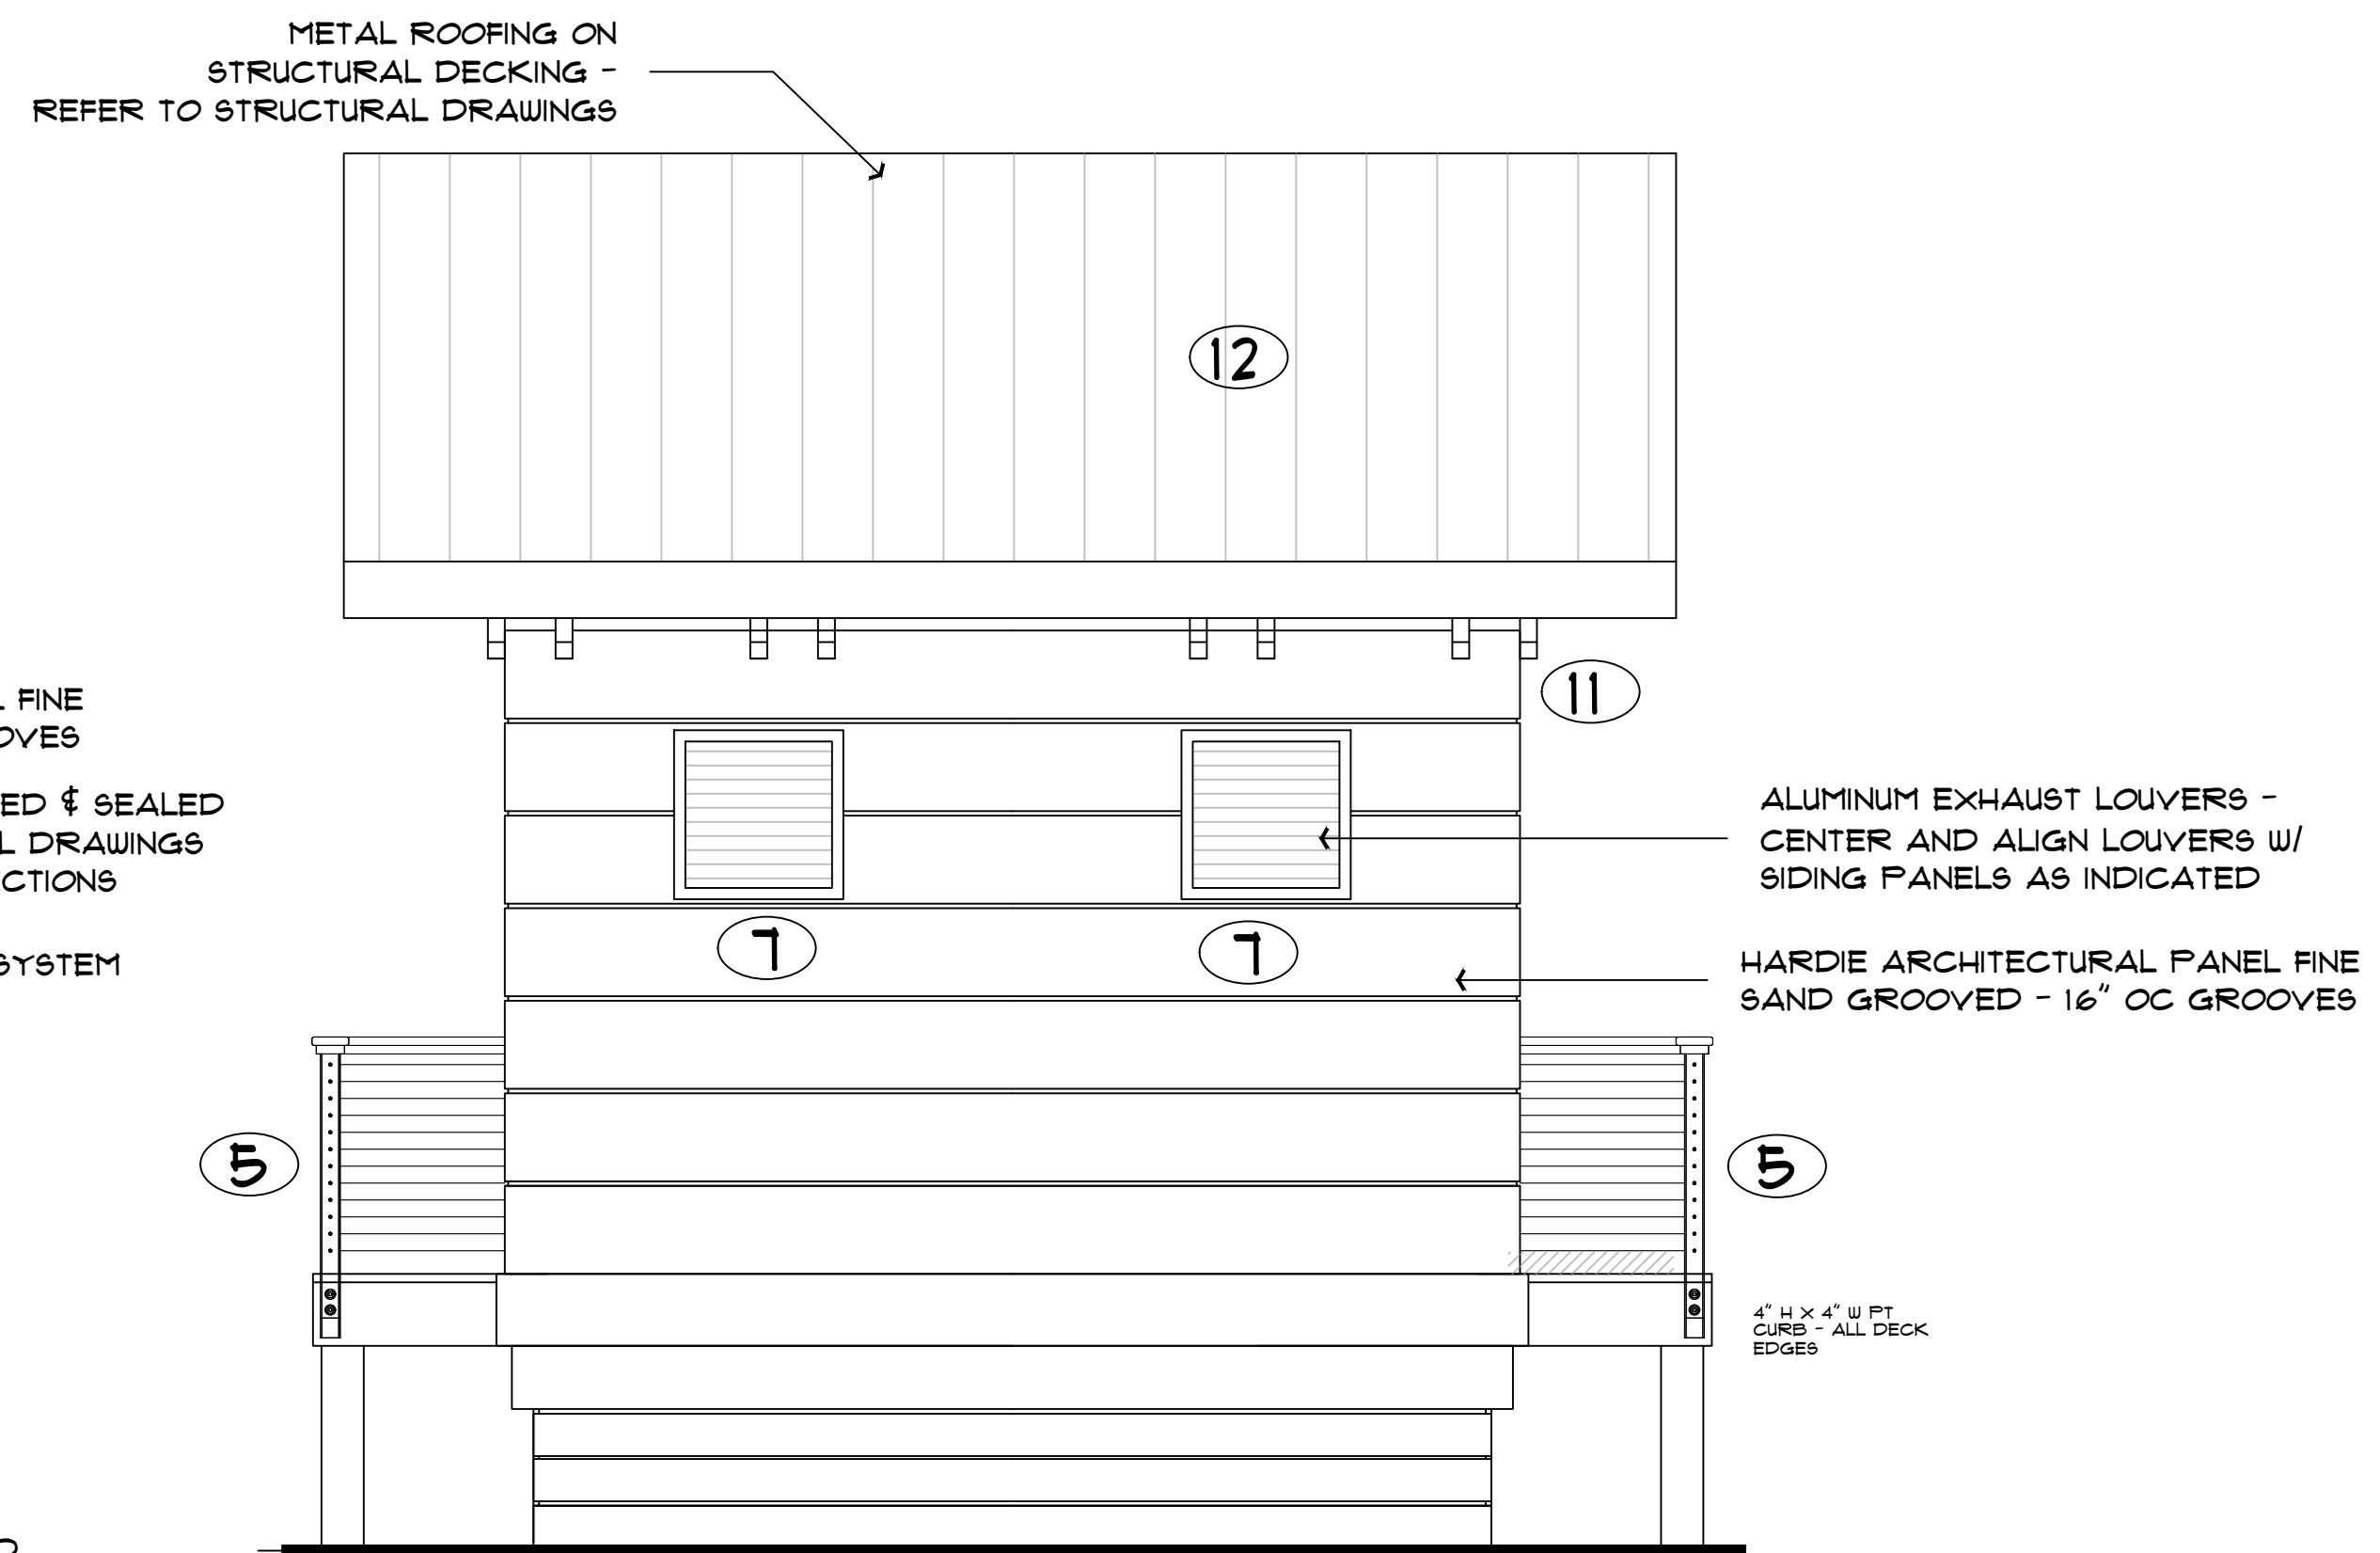

**REAR ELEVATION**  
 NOTE: RAMP NOT SHOWN FOR CLARITY  
 REFER TO CIVIL DRAWINGS FOR RAMP DESIGN

**ELEVATIONS**  
 SCALE: 3/8" = 1'-0"


RUSSELL JOHNSON ARCHITECT PL  
 ARCHITECTURE  
 850 630 4483  
 AR 00012593  
 rajarch@msn.com

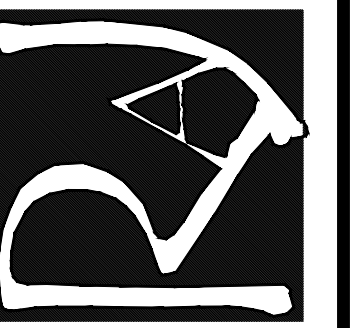

RESTROOMS  
 7TH STREET


**LEGEND**

- ① ADA COMPLIANT RAMP - REFER TO CIVIL DRAWINGS
- ② COVERED ENTRY DECK - PROVIDE 6" W TREX DECKING  
COLOR AS SELECTED BY OWNER - ATTACH W/  
STAINLESS STEEL MARINE GRADE SCREWS
- ③ 2 X 6 SYP#2 WOOD FRAMED WALL - REFER TO  
REFER TO STRUCTURAL DRAWINGS FOR DETAILING  
PROVIDE R 13 INSULATION  
PROVIDE VAPOR BARRIER AND  
FIBERCEMENT SMOOTH PANELS INTERIOR  
FIBERCEMENT SMOOTH PANELS EXTERIOR
- ④ 8X8 FT COLUMN - REFER TO STRUCTURAL DRAWINGS  
FOR CONNECTION DETAILS - CHAMFER ALL EXPOSED EDGES
- ⑤ 42" H RAILINGS - CABLE RAILING SYSTEM BY "VIEWRAIL" OR APPROVED EQUAL  
CABLES TO BE 2205 GRADE COASTAL STAINLESS STEEL, MAX 3" SPACING  
SUPPORTS SHALL BE STAINLESS STEEL 2205 SERIES, 9IDE MOUNT  
ALL HARDWARE SHALL BE STAINLESS STEEL  
HANDRAIL SHALL BE 2" X 1" 2205 STAINLESS STEEL "VIEWRAIL" PRODUCT.  
POST SPACING SHALL BE PER MANUFACTURER'S REQUIREMENTS TO MEET  
FLORIDA BUILDING CODE 2020.
- ⑥ 3'-0" W X 8'-0" H FIBERGLASS DOOR - IMPACT RATED  
WITH FLORIDA PRODUCT APPROVAL NUMBER  
"MAHOGANY PLANK" - POWDER COATED FRAME, BLACK  
COMPOSITE FRAME MEETING CODE REQUIREMENTS ARE  
ACCEPTABLE. PROVIDE SS CLOSER, SS HINGES, SS COMPLIANT  
LEVER LOCKSET (LOCKABLE FROM THE INTERIOR), WEATHER  
SEAL AND ALUMINUM ADA COMPLIANT THRESHOLD.  
ALL HARDWARE SHALL BE HEAVY DUTY COMMERCIAL  
GRADE AND SHALL BE APPROVED BY OWNER PRIOR  
TO BIDDING/PURCHASING.
- ⑦ ALUMINUM LOUVERS W/ BIRD SCREEN, BLACK COASTAL RATED FINISH -  
PROVIDE 1 X 4 AZTEK OR EQUAL PAINTED TRIM TO MATCH DOOR  
COORDINATE W/ MECHANICAL DRAWINGS
- ⑧ HARDIE ARCHITECTURAL PANELS - REFER TO ELEVATIONS  
- PAINTED WHITE
- ⑨ PLUMBING FIXTURES - ADA COMPLIANT - REFER TO A105  
SUBMIT SHOP DRAWINGS TO OWNER FOR APPROVAL  
PRIOR TO PURCHASE
- ⑩ PROVIDE CONCRETE FLOORING, 1.5" MAX OVER WOOD SUBFLOOR.  
CONCRETE SHALL BE A MANUFACTURED SYSTEM INCLUDING THE  
CONCRETE/ PRIMER / LATH ETC AS REQUIRED BY THE MANUFACTURER  
FOR A COMPLETE SYSTEM. SUBMIT FULL SHOP DRAWINGS & SPECS FOR  
OWNER APPROVAL. SLOPE TO FLOOR DRAINS. WOOD SUBFLOOR  
SHALL BE PER STRUCTURAL DRAWINGS, BUT A MIN. OF 3/4" THICK, T&G  
UNTREATED APA-RATED, TYPE I, EXTERIOR GRADE PLYWOOD. PROVIDE  
AN EPOXY OR APPROVED EQUAL COATING W/ NON-SLIP ADDITIVES TO  
MEET OR EXCEED ADA & OSHA WET AND DRY DCOF STANDARDS.  
PROVIDE A 6" RUBBER BASE (BLACK) W/ COVE TRANSITION TO EPOXY  
FLOORING. COORDINATE TOTAL FLOOR THICKNESS W/ ADA COMPLIANT  
DOOR THRESHOLD.
- ⑪ EXPOSED RAFTER TAILS - TAPER AS INDICATED
- ⑫ METAL ROOFING ON STRUCTURAL DECKING PER STRUCTURAL DRAWINGS.  
ON SYNTHETIC CODE APPROVED UNDERLAYMENT. W/ METAL DRIP EDGE MATCHING ROOFING  
PROVIDE A METAL FASCIA MATCHING ROOFING AS REQUIRED TO CONCEAL ROOF JOISTS.  
ROOFING TO BE ALUMINUM STANDING SEAM, CONCEALED FASTENER  
WITH A FLORIDA PRODUCT APPROVAL NUMBER, ATTACHED  
PER THE MANUFACTURER'S REQUIREMENTS TO MEET WIND LOADS.  
ROOFING SHALL BE A COMPLETE ASSEMBLY WITH ALL FLASHINGS, ETC  
ROOFING FINISH SHALL BE FLUROTHANE COASTAL COATING  
PREMIUM FLUOROPOLYMER (PVDF) SYSTEM BY VALSPAR  
WITH A MINIMUM COASTAL WARRANTY 20/20/20  
OR APPROVED EQUAL
- ⑬ LIGHT FIXTURE - REFER TO ELECTRICAL DRAWINGS
- ⑭ (2) ROWS 2 X 6 WOOD FRAMED WALL - PROVIDE SMOOTH  
FIBER CEMENT PANELS FOR INTERIOR SURFACES  
OVER 1/2" FT PLYWOOD SHEATHING  
PROVIDE 1 X 4 AZTEK FLOOR BASE  
PROVIDE (2) ROWS OF 4" SOUND INSULATION
- ⑮ OUTDOOR SHOWER - ADA COMPLIANT  
PROVIDE UNDER DECK DRAIN SYSTEM  
TO COLLECT WATER TO FLOOR DRAIN  
COORDINATE W/ PLUMBING DRAWINGS
- ⑯ PROVIDE SS SHOWER CONTROLS  
HIDDEN WITHIN AN 8FT TALL "COLUMN"  
CONSTRUCTED W/ (4) 2X6 FT VERTICALS  
ENCASED W/ PAINTED HARDIE TRIM

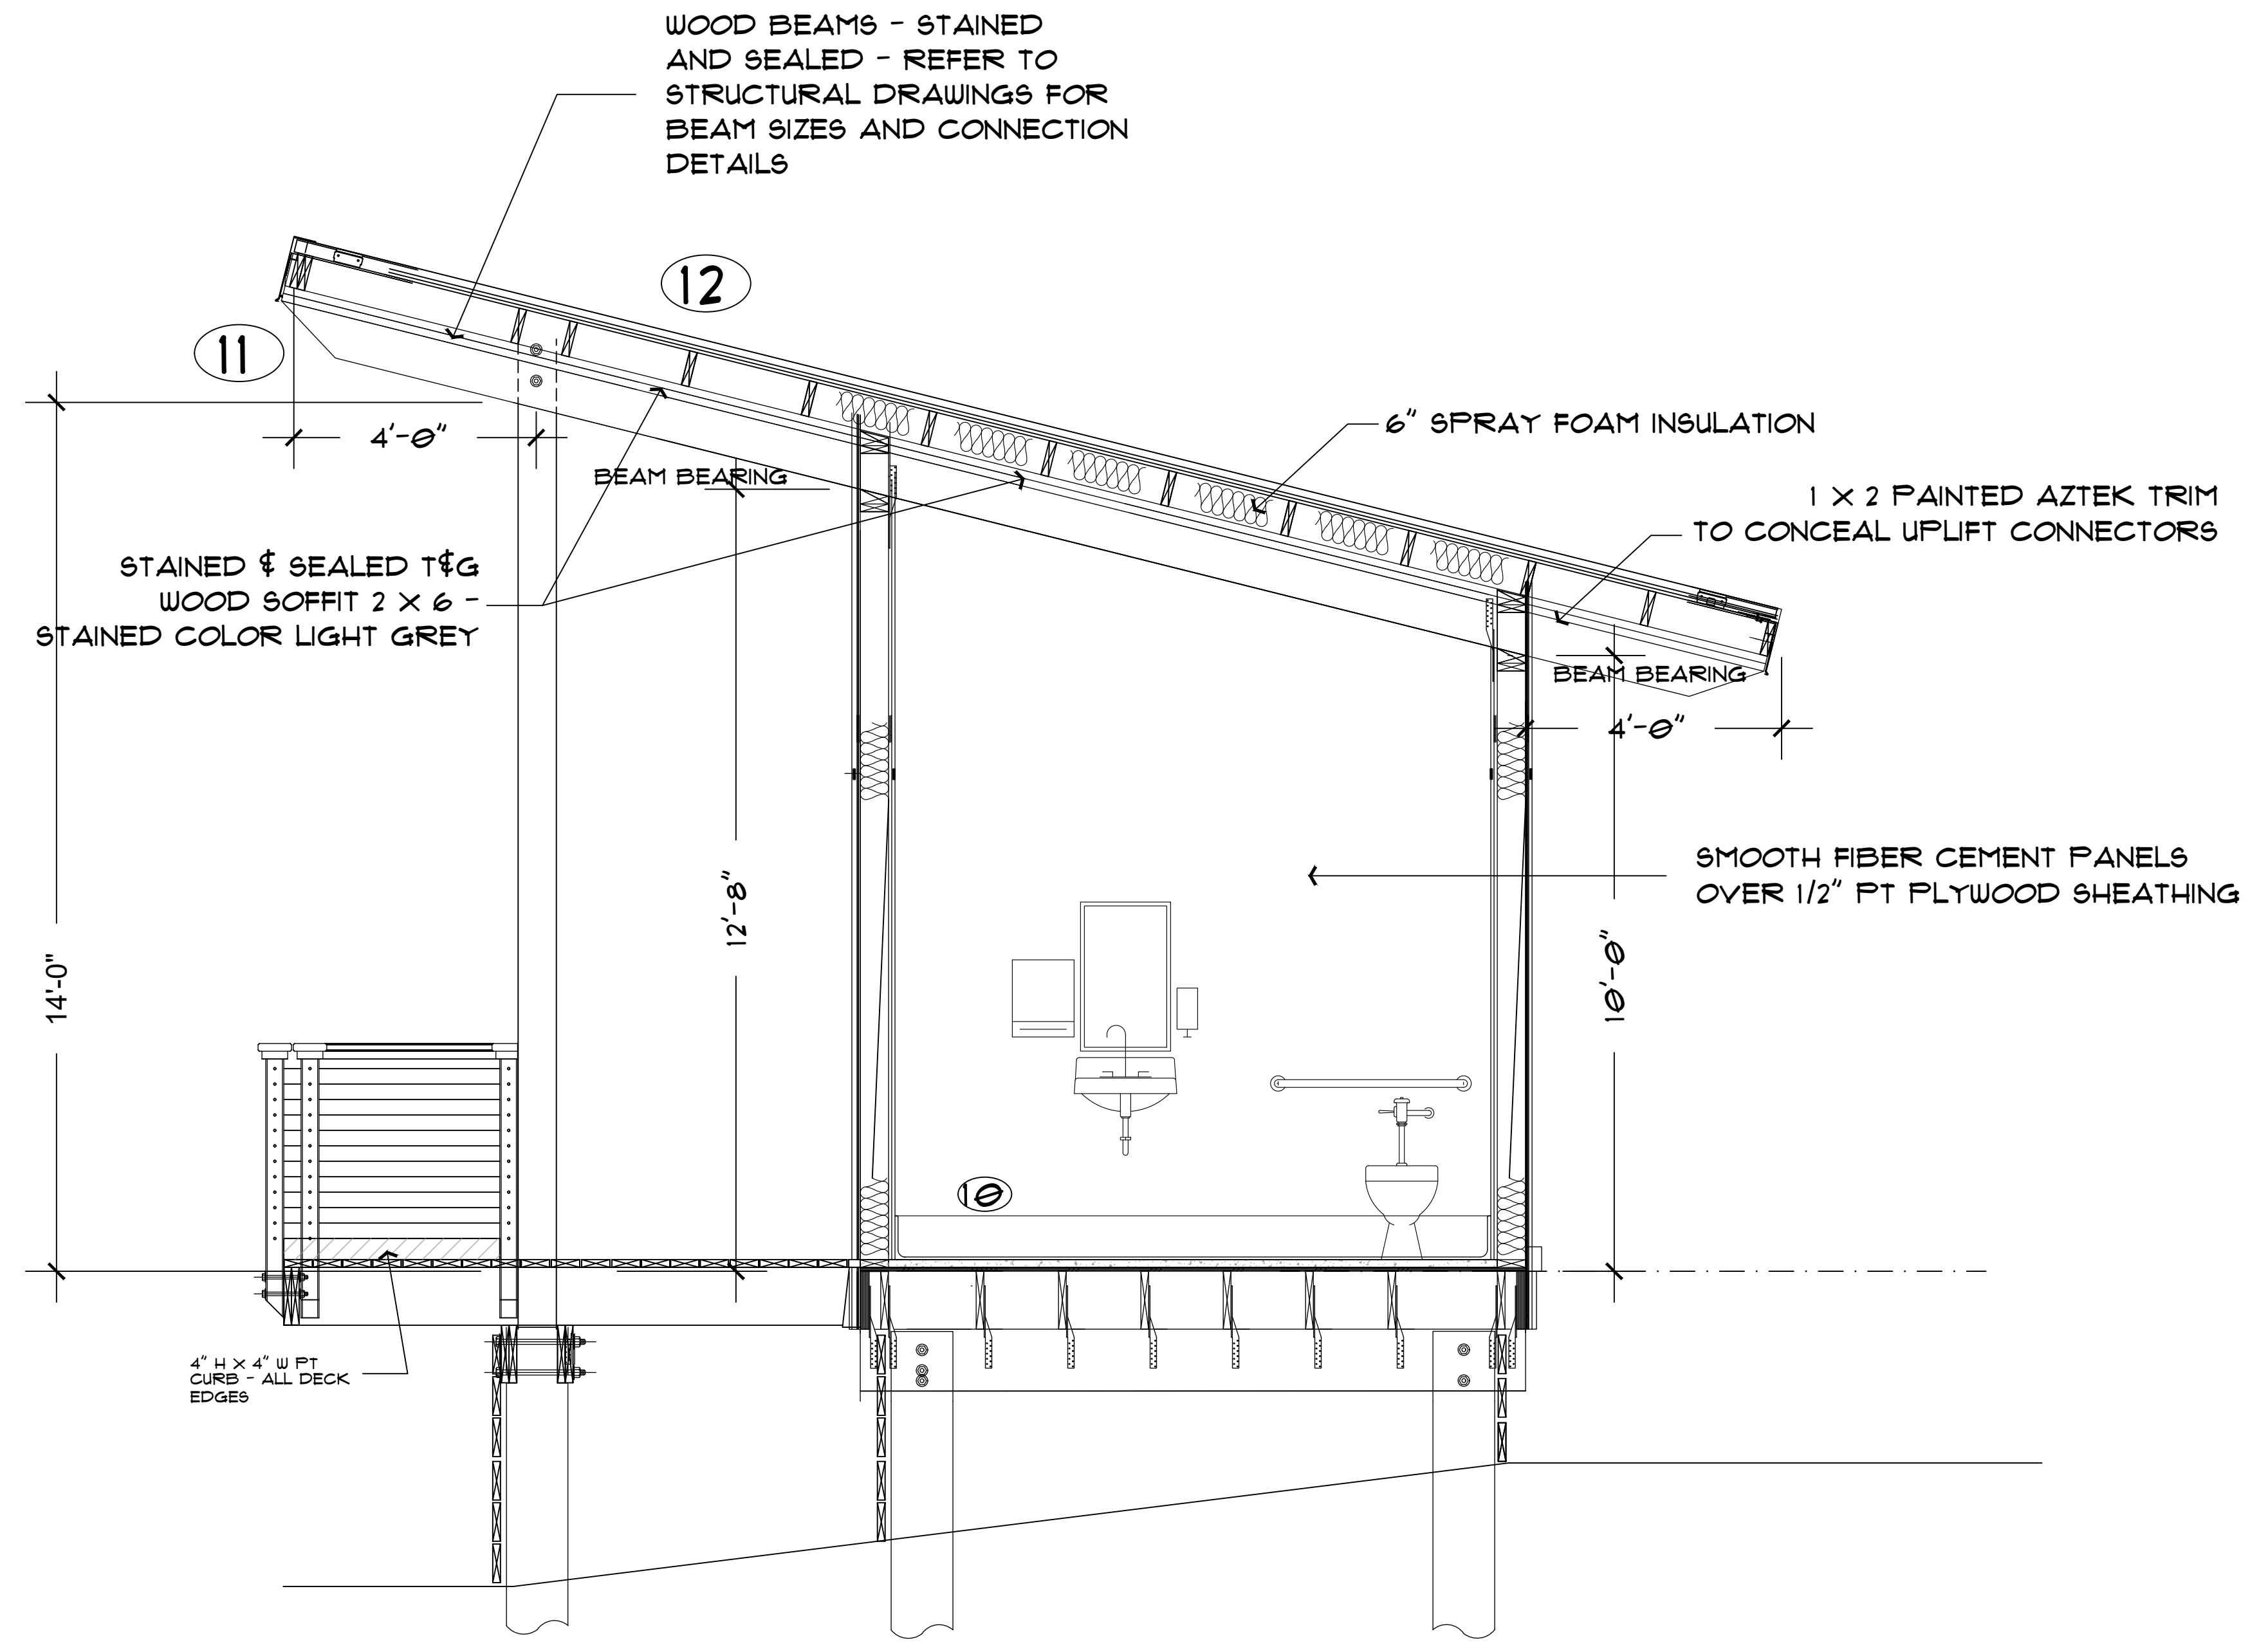

**BUILDING SECTION**

**BUILDING SECTION**  
SCALE: 1/2" = 1'-0"

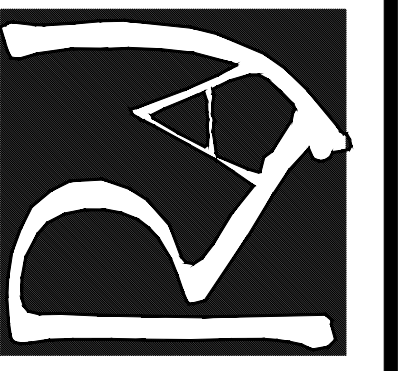

MANUFACTURERS CONSIDERED EQUAL MUST SUBMIT TO ENGINEER 10 DAYS PRIOR TO BID FOR APPROVAL.

### LIGHTING FIXTURE SCHEDULE


MARK	MANUFACTURER AND CATALOG No. (or approved equal)	LAMPS		MOUNTING	REMARKS
		No.	TYPE		
BPW	OML-EM-BZ-MB	600	LED	CEILING RECESSED	WET LOCATION LED EMERGENCY LIGHT, UNIVERSAL VOLTAGE BALLAST
LW	LCD VSA4-4000-1W43-40-80-VAR-DM-OP-WH-PH-65	36W LED ARRAY 4100 LUMEN/4000K		CEILING SURFACE	1' X 4' SURFACE MOUNTED LED STAIRWELL WRAP, 120V
LWE	LCD VSA4-4000-1W43-40-80-VAR-DM-OP-WH-PH-65-EM	36W LED ARRAY 4100 LUMEN/4000K		CEILING SURFACE	1' X 4' SURFACE MOUNTED LED STAIRWELL WRAP, 120V
WB	KIRLIN TST-07180-LED(590nm)-BV	20W LED ARRAY 506 LUMEN/4000K		CEILING SURFACE	WALL MOUNTED AREA TURTLE SAFE LIGHT, 590nm AMBER LED, FINISH SELECTED BY ARCHITECT

NOTE: NO EQUALS WILL BE ALLOWED FOR TURTLE LIGHTING

# WARNING

Arc Flash Hazard  
Appropriate PPE Required

Do not operate controls or open covers without appropriate personal protection equipment. Failure to comply may result in injury or death!

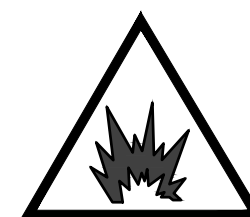

REFER TO NFPA 70E FOR MINIMUM PPE REQUIREMENTS

### TYPICAL ARC FLASH HAZARD LABEL DETAIL

NOT TO SCALE

#### ARC FLASH LABEL DETAIL NOTES:


- PROVIDE SELF-ADHESIVE VINYL LABEL TO AFFIX TO ALL PANEL AND SWITCHBOARDS IN ACCORDANCE WITH NEC 110.16 AND NFPA 70E.
- LABELING MAY BE COMPLETED BY EQUIPMENT MANUFACTURER, VENDOR, OR CONTRACTOR. THE CONTRACTOR SHALL VERIFY ALL PANELS AND SWITCHBOARDS ARE LABELED IN THE FIELD.
- THE LABEL SHALL BE LOCATED ON THE EQUIPMENT TO BE CLEARLY VISIBLE TO QUALIFIED PERSONS BEFORE EXAMINATION, ADJUSTMENT, SERVICING, OR MAINTENANCE OF THE EQUIPMENT.

120/240 VOLT 1Ø 3W 100 AMP MAIN BREAKER		CIRCUIT BREAKER PANEL SCHEDULE LOADCENTER M7				FLUSH MOUNTED NEMA 3R ENCLOSURE PROVIDE LOCKABLE COVER			
CKT	LOAD DESCRIPTION	BREAKER		LOAD KVA		BREAKER		LOAD DESCRIPTION	CKT
		POLE	AMP	AMP	POLE	AMP	POLE		
1	EF-1 (1/4HP)	1	20	.70	1.00	15	2	WOMEN'S WALL HEATER	2
3	EF-2 (1/4HP)	1	20	.70		15	2	MEN'S WALL HEATER	4
5	LTS-RESTROOMS, EXTERIOR	1	20	.50	1.00	15	2	MEN'S WALL HEATER	6
7	REC-EXTERIOR	1	20	.18		15	2	MEN'S WALL HEATER	8
9	SPARE	1	20		4.16	30	2	WOMEN'S IWH-1	10
11	SPARE	1	20			30	2	WOMEN'S IWH-1	12
13	SPARE	1	20		4.16	30	2	MEN'S IWH-1	14
15	SPARE	1	20			30	2	MEN'S IWH-1	16
17	SPACE	1	---			---	1	SPACE	18
19	SPACE	1	---			---	1	SPACE	20
21	SPACE	1	---			---	1	SPACE	22
23	SPACE	1	---			---	1	SPACE	24

TOTAL CONNECTED LOAD: 12.40 KVA  
MINIMUM INTERRUPTING CAPACITY: 10,000 AMPS SYMMETRICAL

### ELECTRICAL GENERAL NOTES

- CONTRACTOR SHALL COORDINATE ALL WORK WITH OTHER TRADES PRIOR TO INSTALLATION. REFER TO MECHANICAL AND PLUMBING DRAWINGS FOR EXACT SIZE AND LOCATION OF EQUIPMENT WHICH IS FURNISHED BY OTHERS AND CONNECTED BY ELECTRICAL.
- RECEPTACLES, SWITCHES AND COVERPLATES COLOR SHALL BE SELECTED BY THE ARCHITECT FROM STANDARD COLORS.
- LOCATION OF LIGHTING FIXTURES, DISCONNECT SWITCHES, ETC. FOR MECHANICAL EQUIPMENT/ROOM SHALL BE COORDINATED WITH FINAL MECHANICAL EQUIPMENT LOCATION TO PROVIDE NATIONAL ELECTRIC CODE REQUIRED ACCESS SPACE.
- FINAL CONNECTION TO ALL MOTORS SHALL BE WITH FLEXIBLE CONDUIT CONNECTION.
- ALL PANELBOARDS, BACKBOARDS, TERMINAL CABINETS, DISCONNECTS, ETC SHALL HAVE CUSTOM ENGRAVED MICARTA NAMEPLATE MECHANICALLY AFFIXED IDENTIFYING SYSTEM.
- GENERAL CONTRACTOR SHALL FIELD-VERIFY ALL EXISTING CONDITIONS PRIOR TO BEGINNING ANY WORK, AND SHALL IMMEDIATELY NOTIFY THE ARCHITECT OF ANY DISCREPANCIES. FAILURE TO DO SO INDICATES THAT THE CONTRACTOR ACCEPTS THE CONDITIONS AS THEY EXIST, AND SHALL PERFORM THE WORK REQUIRED AS SHOWN AND SPECIFIED.
- THE ELECTRICAL CONTRACTOR SHALL OBTAIN AND REVIEW THE MECHANICAL AND SPECIAL EQUIPMENT SUBMITTALS PRIOR TO SUBMITTING THE ELECTRICAL SUBMITTALS. ANY ELECTRICAL EQUIPMENT, CONDUIT, AND WIRE SIZE CHANGES RESULTING FROM THIS REVIEW SHALL ALSO BE SUBMITTED FOR APPROVAL.
- FURNISH ALL EQUIPMENT AND LABOR, PERFORM ALL LABOR WITH SUPERVISION, BEAR ALL EXPENSES, AS NECESSARY FOR THE SATISFACTORY COMPLETION OF ALL WORK READY FOR OPERATION.
- COMPLY WITH ALL LOCAL CODE, LAWS, AND ORDINANCES APPLICABLE TO ELECTRICAL WORK, THE STATE BUILDING CODE AND THE NATIONAL ELECTRIC CODE. OBTAIN ALL PERMITS REQUIRED BY LOCAL ORDINANCES.
- THE GENERAL CONTRACTOR SHALL NOTIFY THE COR IMMEDIATELY OF ANY CONFLICTS/DISCREPANCIES BETWEEN DISCIPLINES BEFORE ORDERING EQUIPMENT/MATERIALS.
- ALL CONDUCTORS INDICATED ON PLAN SHALL BE COPPER.
- THE CONTRACTOR SHALL VERIFY ALL ELECTRICAL REQUIREMENTS FOR VOLTAGE, AMPERAGE, PHASE, RECEPTACLES, ETC. PRIOR TO CONNECTING OWNER FURNISHED EQUIPMENT. THE CONTRACTOR SHALL IMMEDIATELY NOTIFY THE ARCHITECT/ENGINEER OF ANY DISCREPANCIES BETWEEN THE PLANS AND FURNISHED EQUIPMENT PRIOR TO CONNECTING EQUIPMENT.
- FURNISH ALL EQUIPMENT AND LABOR, PERFORM ALL LABOR WITH SUPERVISION, BEAR ALL EXPENSES, AS NECESSARY FOR THE SATISFACTORY COMPLETION OF ALL WORK READY FOR OPERATION.
- OBTAIN OWNER'S APPROVAL OF ALL LIGHT FIXTURES, SWITCHES, RECEPTACLES, PANELBOARDS, ETC. PRIOR TO PURCHASING.
- THE ELECTRICAL WORK SHALL BE INSTALLED IN A NEAT AND WORKMANLIKE MANNER. ALL NOT SO INSTALLED SHALL BE REMOVED AND REPLACED AT NO COST TO THE OWNER.
- ALL CONDUCTORS LESS THAN 100A. SHALL BE COPPER #12 & #10 SOLID, #8 AND LARGER STRANDED, #6 AND SMALLER TO BE TYPE TW, 600 VOLT INSULATION AND TYPE THW FOR #4 AND LARGER.
- EQUIPMENT GROUNDING CONDUCTOR SHALL BE PULLED IN ALL BRANCH CIRCUIT WIRING. CONDUIT GROUND SHALL NOT BE ACCEPTABLE.

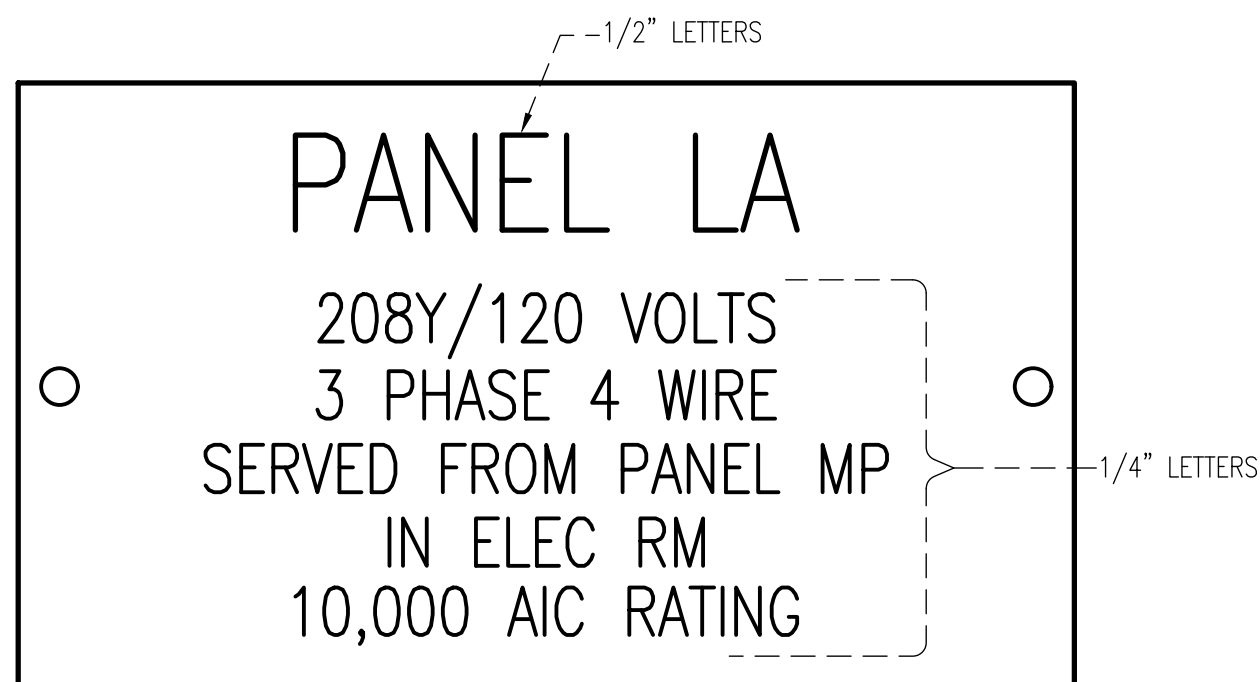


### TYPICAL ELECTRICAL EQUIPMENT IDENTIFICATION DETAIL

NOT TO SCALE

#### ELECTRICAL EQUIPMENT IDENTIFICATION DETAIL NOTES:

- MECHANICALLY AFFIX NAMEPLATE TO PANELBOARDS, CONTROL PANELS, MOTOR CONTROL CENTERS, DISCONNECTS, STARTERS OR SIMILAR DEVICES.
- LETTERS SHALL BE WHITE ON BLACK BACKGROUND; SIZE OF LETTERS INDICATED ON DETAIL.
- INFORMATION IN LABEL IS A GENERIC EXAMPLE - DESIGNATE EQUIPMENT IN A SIMILAR WAY USING RELEVANT INFORMATION (NAME OF PANEL, VOLTS, PHASE, LOCATION, AIC RATING ETC.) ACCORDING TO EACH INDIVIDUAL LOCATION OF EQUIPMENT.

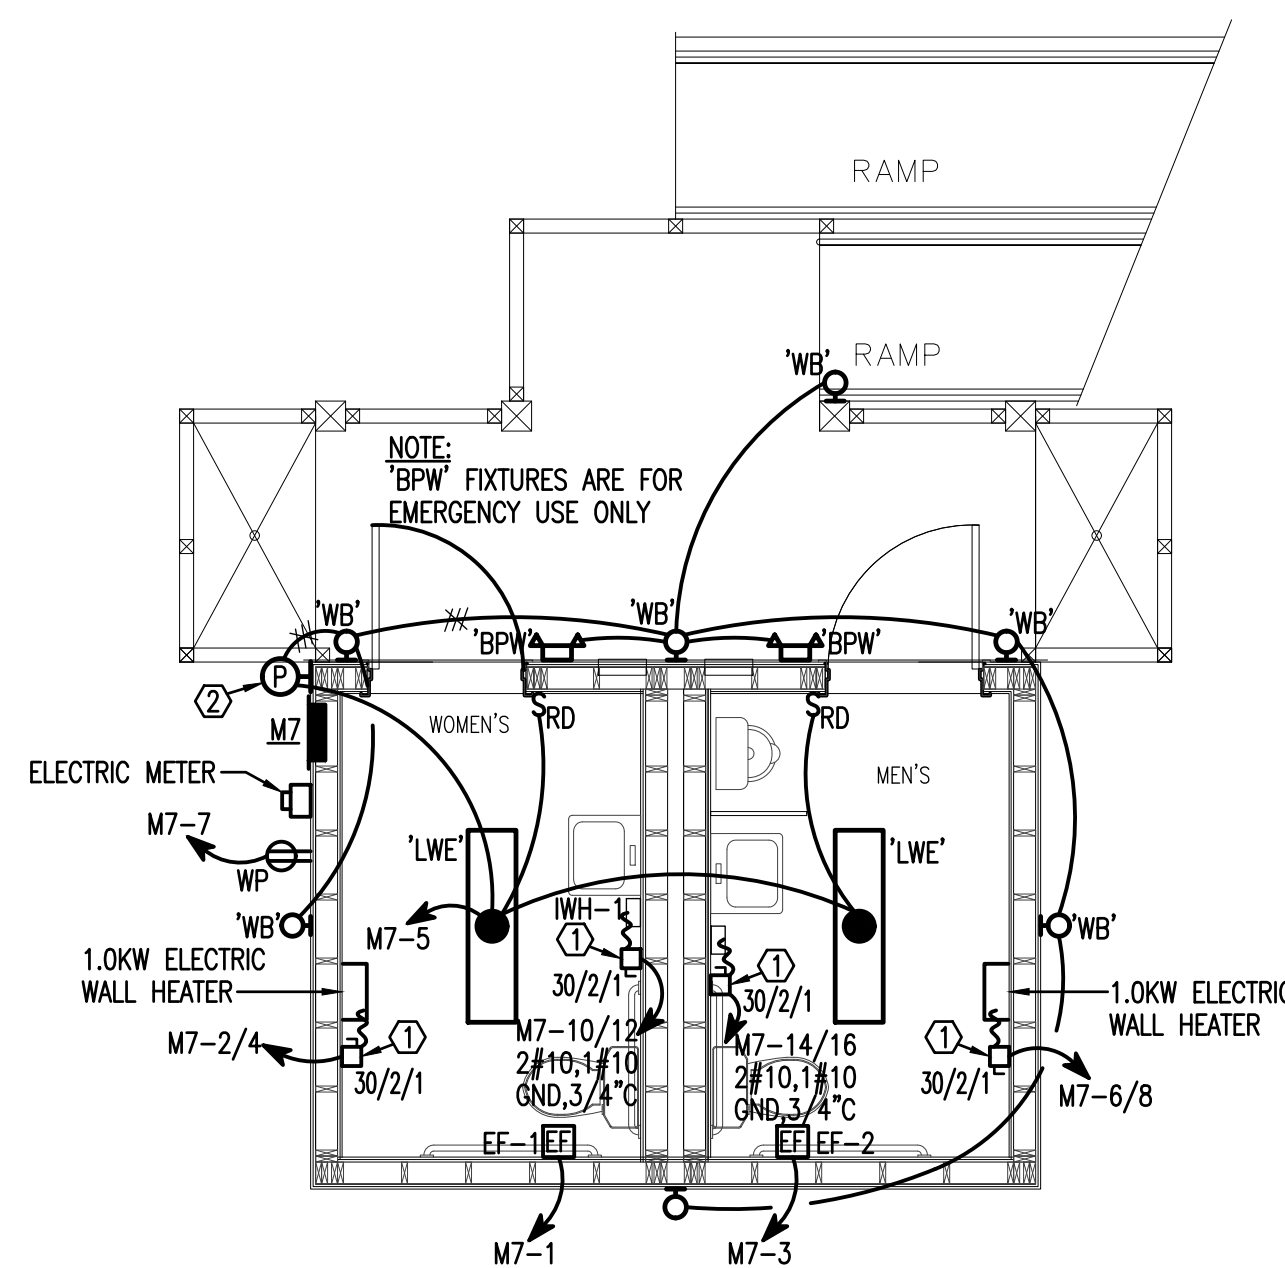

### ELECTRICAL PLAN 7TH ST BEACH RESTROOM


SCALE: 1/4"=1'-0"

#### KEYNOTES:

- INSTALL SMALL FORM DISCONNECT WITH LOCKABLE HASP
- SIDEWALL MOUNTED PHOTOCELL EQUAL TO TORK #2101; INSTALL PER MANUFACTURER'S RECOMMENDATIONS
- 2#10, #10 GND, 3/4"

### ELECTRICAL LEGEND

- "A" SURFACE MOUNTED LINEAR LED FIXTURE, MARK 'A'
- SURFACE MOUNTED LINEAR LED FIXTURE WITH EMERGENCY UNIT BATTERY PACK
- EXHAUST FAN
- WP DUPLICATION RECEPTACLE - 20 AMP, 125 VOLT, GFI, 2 POLE, 3 WIRE GROUNDED TYPE, NEMA 5-20R. MOUNT 18" A.F.F. UNLESS NOTED OTHERWISE; PROVIDE WEATHERPROOF BOX FOR RECEPTACLE
- G DUPLICATION RECEPTACLE - 20 AMP, 125 VOLT, GFI, 2 POLE, 3 WIRE GROUNDED TYPE, NEMA 5-20R. MOUNT 48" A.F.F. UNLESS NOTED OTHERWISE
- WALL MOUNTED H.I.D. AREA LIGHT
- RUN CONCEALED UNDERGROUND
- HOMERUN TO PANEL. ANY CIRCUIT WITHOUT FURTHER IDENTIFICATION INDICATES 2 #12, 1 #12 GROUND - 3/4" C; 3 #12, 1 #12 GROUND - 1/2" C; 4 #12, 1 #12 GROUND - 3/4" C, ETC. AS PER NEC. LETTERS AND NUMERALS INDICATE PANEL AND CIRCUIT NUMBER.
- LIQUID-TIGHT FLEXIBLE CONDUIT CONNECTION
- SURFACE MOUNTED CONDUIT; RUN PARALLEL OR PERPENDICULAR TO STRUCTURE LINES
- JUNCTION BOX
- 120/240 VOLT FLUSH MOUNTED PANELBOARD
- NON-FUSIBLE DISCONNECT SWITCH; XX/YY/ZZ WHERE X INDICATES AMPERAGE, Y INDICATES # OF POLES, AND Z INDICATES NEMA RATING
- A.F.F. ABOVE FINISH FLOOR
- WP WEATHERPROOF
- U.N.O. UNLESS NOTED OTHERWISE

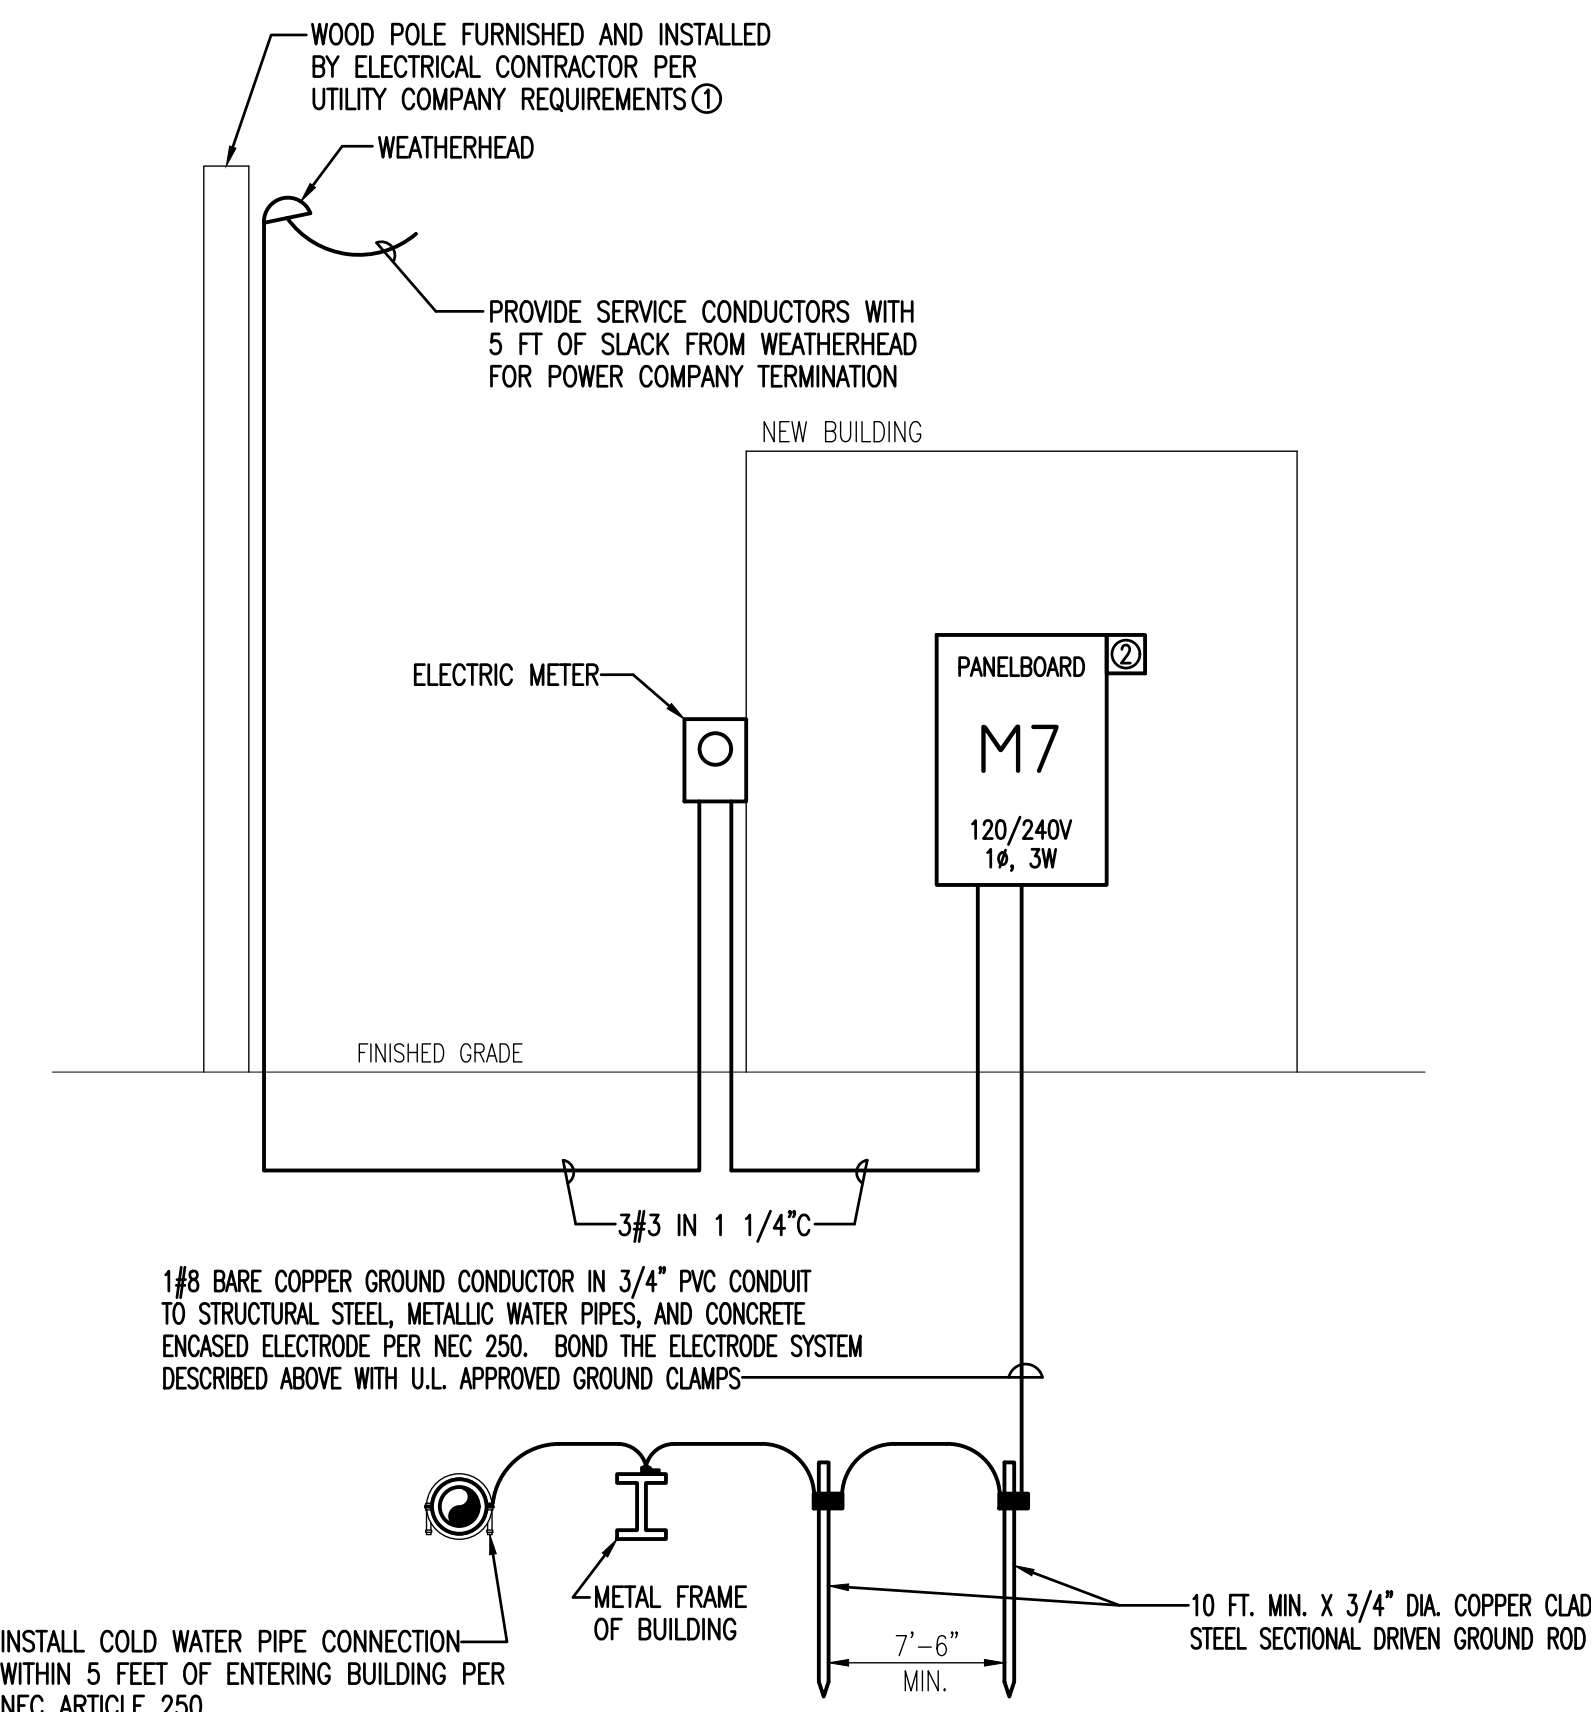

### POWER RISER DIAGRAM 7TH STREET BEACH RESTROOM

NOT TO SCALE

#### POWER RISER DIAGRAM KEYNOTES:

- INSTALL POLE PER ELECTRIC UTILITY COMPANY REQUIREMENTS. COORDINATE WITH ELECTRIC UTILITY COMPANY.
- PROVIDE INTEGRAL SURGE SUPPRESSOR DEVICE IN PANEL WITH 40KA PER MODE/80KA PER PHASE, INDICATING LIGHTS AND ALARM SURGE COUNTER. SURGE SUPPRESSOR SHALL BE EATON SPC SERIES, VERIFY VOLTAGE AND PHASES. INSTALL ACCORDING TO MANUFACTURER'S RECOMMENDATIONS.


**Johnson, Peaden  
 Engineering, Inc.**

329 Brooks Street SE  
 Fort Walton Beach, FL 32548  
 (850) 244-6189

827 Grace Avenue  
 Panama City, FL 32401  
 (850) 215-4068

Alabama CD-2429-E  
 Arkansas 1654  
 Florida 00009014  
 Georgia PEF003983  
 Mississippi E-00000862  
 Tennessee 737347

These plans, ideas & concepts contained herein including any digital information are the sole property of Johnson, Peaden Engineering, Inc. They are not to be reproduced, copied, modified or changed without the express written permission and consent of Johnson, Peaden Engineering, Inc.

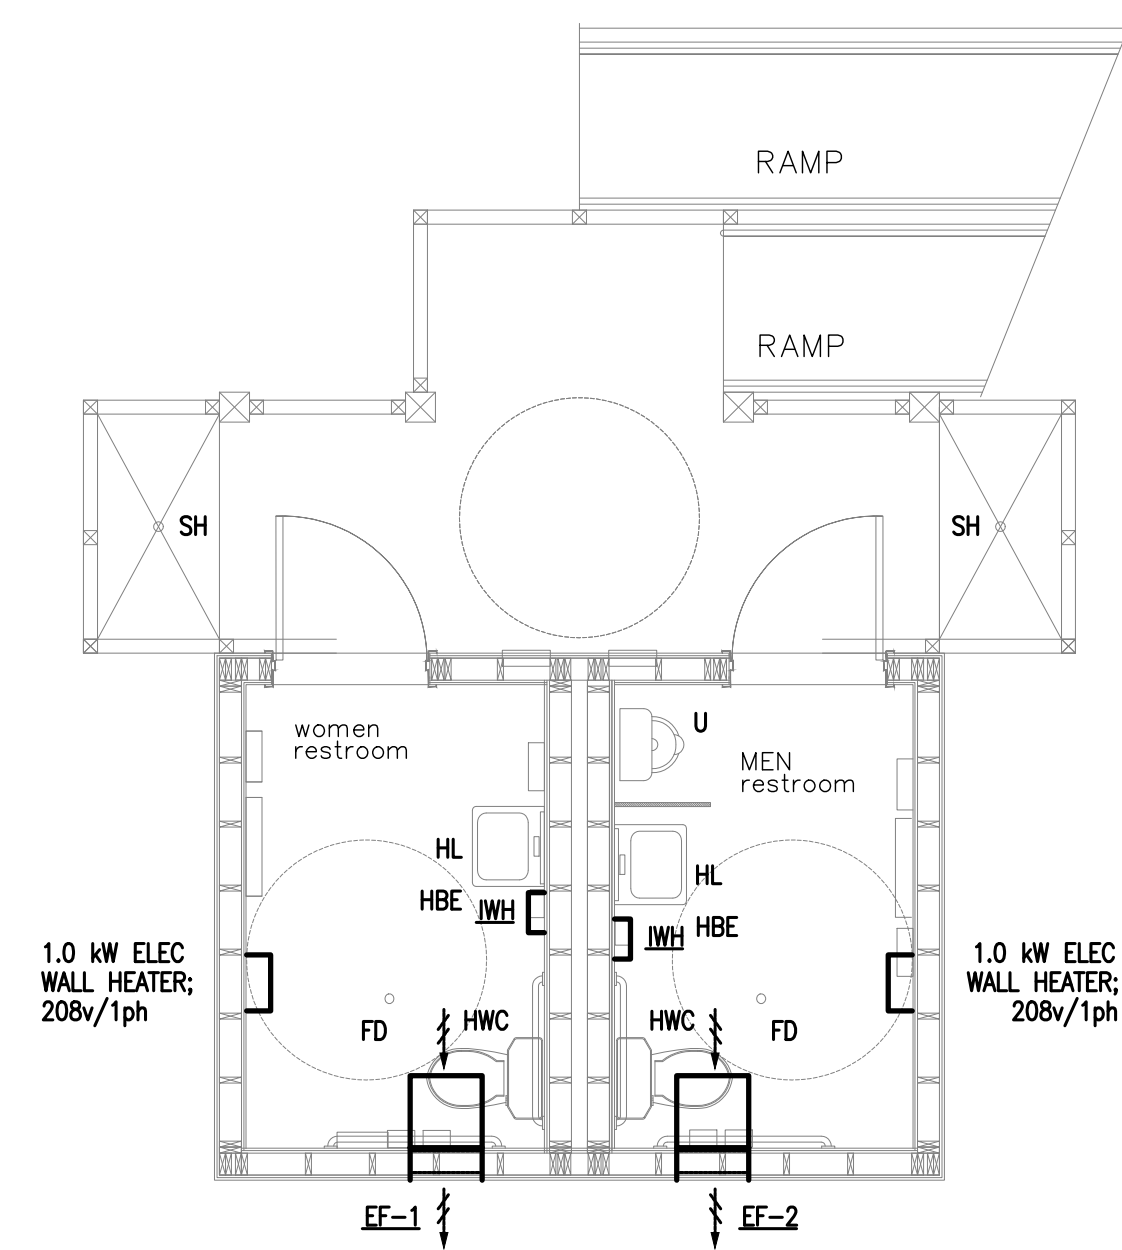



**HVAC FLOOR PLAN**  
 SCALE: 1/4" = 1'-0"

VENTILATION FAN SCHEDULE											
MARK	CFM	S.P. "W.G.	MIN. POWER	VOLTAGE/PHASE	MAX. RPM	MAX. SONES	FAN TYPE	DRIVE TYPE	EQUAL TO GREENHECK	CONTROL OR INTERLOCK	NOTES
EF-1, 2	150	0.50	1/4 HP	120/1	1089	9.6	PROP DIRECT	AER-20-03-0605 VG	T*STAT/MOTION		1, 2
EF-3, 4	225	0.50	1/4 HP	120/1	1119	10.1	PROP DIRECT	AER-20-03-0605 VG	T*STAT/MOTION		1, 2
EF-5, 6	300	0.50	1/4 HP	120/1	1150	10.8	PROP DIRECT	AER-20-03-0605 VG	T*STAT/MOTION		1, 2

1. FAN SHALL BE PROVIDED WITH: BACKDRAFT DAMPER, DISCONNECT, THERMAL OVERLOAD PROTECTION, MOUNTED FAN SPEED CONTROLLER, WALL HOUSING, MOTOR GUARD, 4" DEEP LOUVER WITH BIRDSCREEN. LOUVER SHALL BE COMPLIANT WITH FBC-BUILDING (2020).  
 2. T\*STAT SHALL BE SET AT 55° F. MOTION SENSOR SHALL HAVE OVERRIDE CONTROL.

**GENERAL MECHANICAL NOTES**

- FURNISH ALL LABOR, EQUIPMENT, AND MATERIALS TO PROVIDE A COMPLETE MECHANICAL SYSTEM. DUE TO THE SCHEMATIC NATURE OF THESE PLANS, THE CONTRACTOR SHALL FIELD-VERIFY LOCATIONS FOR EQUIPMENT DUCTWORK, AND ACCESSORIES. IN ADDITION, THIS WORK SHALL BE COORDINATED WITH OTHER TRADES TO AVOID CONFLICTS. THE CONTRACTOR SHALL ALSO REVIEW THE STRUCTURAL DRAWINGS BEFORE FABRICATING AND INSTALLING DUCTWORK OR EQUIPMENT.
- ALL WORK SHALL BE PERFORMED BY SKILLED AND EXPERIENCED WORKMEN. WORK SHALL COMPLY WITH ALL APPLICABLE STATE AND LOCAL CODES. THIS CONTRACTOR SHALL BE RESPONSIBLE FOR ALL REQUIRED PERMITS, LICENSES, AND INSPECTIONS.
- ALL MATERIALS SHALL BE NEW AND WITHOUT DEFECTS. SUBMIT SHOP DRAWINGS FOR ALL MATERIALS AND EQUIPMENT. ALL WORK DONE BY THIS CONTRACTOR SHALL BE WARRANTED FOR ONE YEAR FROM THE TIME THE OWNER GIVES ACCEPTANCE OR GAINS BENEFICIAL USE, WHICHEVER IS FIRST. ALL EQUIPMENT SHALL BE INSTALLED PER MANUFACTURER'S RECOMMENDATIONS.
- DUCT SIZES ON DRAWINGS ARE INSIDE CLEAR DIMENSIONS. DUCT SHALL BE OF LOW-PRESSURE (1.0" w.g.) CONSTRUCTION AS CLASSIFIED BY SMACNA UNLESS OTHERWISE NOTED. ALL DUCT SHALL HAVE MINIMUM 1" INTERNAL LINER FOR THE FIRST 20 FEET FOR SOUND ATTENUATION. AFTER 20 FEET, THE CONTRACTOR SHALL USE 2" EXTERNAL WRAP (MINIMUM R-6 FOR BOTH). MINIMUM 1-1/2" THICK, 800 EI-RATED DUCTBOARD MAY BE USED WITH THE APPROVAL OF THE OWNER AND THE ARCHITECT.
- FLEXIBLE DUCT MAY BE INSTALLED ONLY WHERE SHOWN ON THE DRAWINGS. DUCT SHALL BE EXTERNALLY-INSULATED CORRUGATED METAL WITH A MAXIMUM LENGTH OF 8'-0". FOR TAKE-OFFS LONGER THAN 8'-0", THE REMAINDER OF THE DISTANCE SHALL BE EXTERNALLY-WRAPPED SINGLE-WALL ROUND DUCT WITH A SPIN-IN STYLE TAP AT THE MAIN DUCT.
- HANGERS FOR EQUIPMENT AND PIPING SHALL BE SECURED TO THE BUILDING STRUCTURE. NO HANGERS SHALL BE ATTACHED TO THE FLOOR OR ROOF DECK MATERIAL, OR CONCRETE DECKS LESS THAN 4" THICK.
- ALL RETURN AND EXHAUST GRILLES SHALL HAVE OPPOSED-BLADE DAMPERS. ALL SUPPLY-SIDE TAKE-OFFS SHALL HAVE A BALANCING DAMPER.
- FIRE DAMPERS AND FIRE-STOPPING SHALL BE PROVIDED FOR ANY PENETRATIONS OF FIRE-RATED PARTITIONS. VERIFY LOCATIONS OF ALL FIRE-STOPPING ON THE ARCHITECTURAL DRAWINGS.
- ALL GRILLES AND REGISTERS SHALL BE EQUAL TO TITUS WITH ALUMINUM CONSTRUCTION. SUPPLY GRILLES SHALL BE EQUAL TO MODEL TDC. SUPPLY REGISTERS SHALL BE EQUAL TO MODEL 301. RETURN, EXHAUST AND TRANSFER GRILLES SHALL BE EQUAL TO MODEL 355 WITH OPPOSED-BLADE DAMPERS. GRILLE FINISH SHALL BE APPROVED BY THE OWNER AND THE ARCHITECT.
- EQUIPMENT INSTALLED UNDER THIS CONTRACT SHALL BE ABLE TO PROVIDE THE REQUIRED CAPACITIES IN THE MIDDLE OF ITS PERFORMANCE RANGE. ALL COMPRESSORS SHALL HAVE A MINIMUM 5-YEAR WARRANTY UNLESS OTHERWISE NOTED. THE EQUIPMENT SHALL HAVE ALL THE NECESSARY CONTROLS AND ACCESSORIES TO ALLOW FOR FULL OPERATION. IF EQUIPMENT HAS COMPONENTS OF A VIBRATIVE NATURE, THE CONTRACTOR SHALL PROVIDE THE NECESSARY VIBRATION CONTROLS.
- REFRIGERANT PIPING SHALL BE HARD-DRAWN TYPE K OR L COPPER WITH COPPER SOLDER FITTINGS. PIPING SHALL BE SOLDERED WITH SILVER SOLDER AND INSULATED WITH 1/2" THICK THERMAL TUBULAR JACKETING. SEAL INSULATION JOINTS WITH TAPE AND CEMENT OR PER MANUFACTURER'S INSTRUCTIONS. PRE-INSULATED AND PRE-CHARGED REFRIGERANT LINES MAY BE USED AS PROVIDED BY THE EQUIPMENT MANUFACTURER. WHERE INSULATION IS EXPOSED TO WEATHER PROTECT LINES WITH AN ALUMINUM COVER AND PAINT TO MATCH EXTERIOR FINISH.
- CONDENSATE DRAINS SHALL BE FULL-SIZE (3/4" MINIMUM) COPPER OR SCHEDULE 40 PVC. DRAINS SHALL BE INSULATED IN THE SAME MANNER AS REFRIGERANT LINES. SPILL ON GRADE ADJACENT TO OUTDOOR UNITS.
- CONTROLS SHALL BE EQUAL TO MANUFACTURER'S CONTROLS. OUTDOOR UNITS SHALL HAVE FACTORY-WIRED TIME DELAYS, PRESSURE SWITCHES, LOW-AMBIENT CONTROLS AND DEFROST CONTROLS. THERMOSTATS SHALL BE DIGITAL AND PROGRAMMABLE WITH BATTERY BACK-UP. SETPOINTS SHALL FOLLOW DESIGN CONDITIONS OR BE AS DIRECTED BY THE OWNER. MOUNT ALL THERMOSTATS AND TEMPERATURE SENSORS 60" A.F.F.
- THE HVAC SYSTEM SHALL BE TESTED AND BALANCED ACCORDING TO AABC STANDARDS. THE CONTRACTOR SHALL PROVIDE THE ARCHITECT WITH A COPY OF THE TEST AND BALANCE REPORT AND THE OWNER WITH A LETTER STATING THAT THE SYSTEM(S) HAVE BEEN BALANCED TO WITHIN 10% OF DESIGN PARAMETERS.

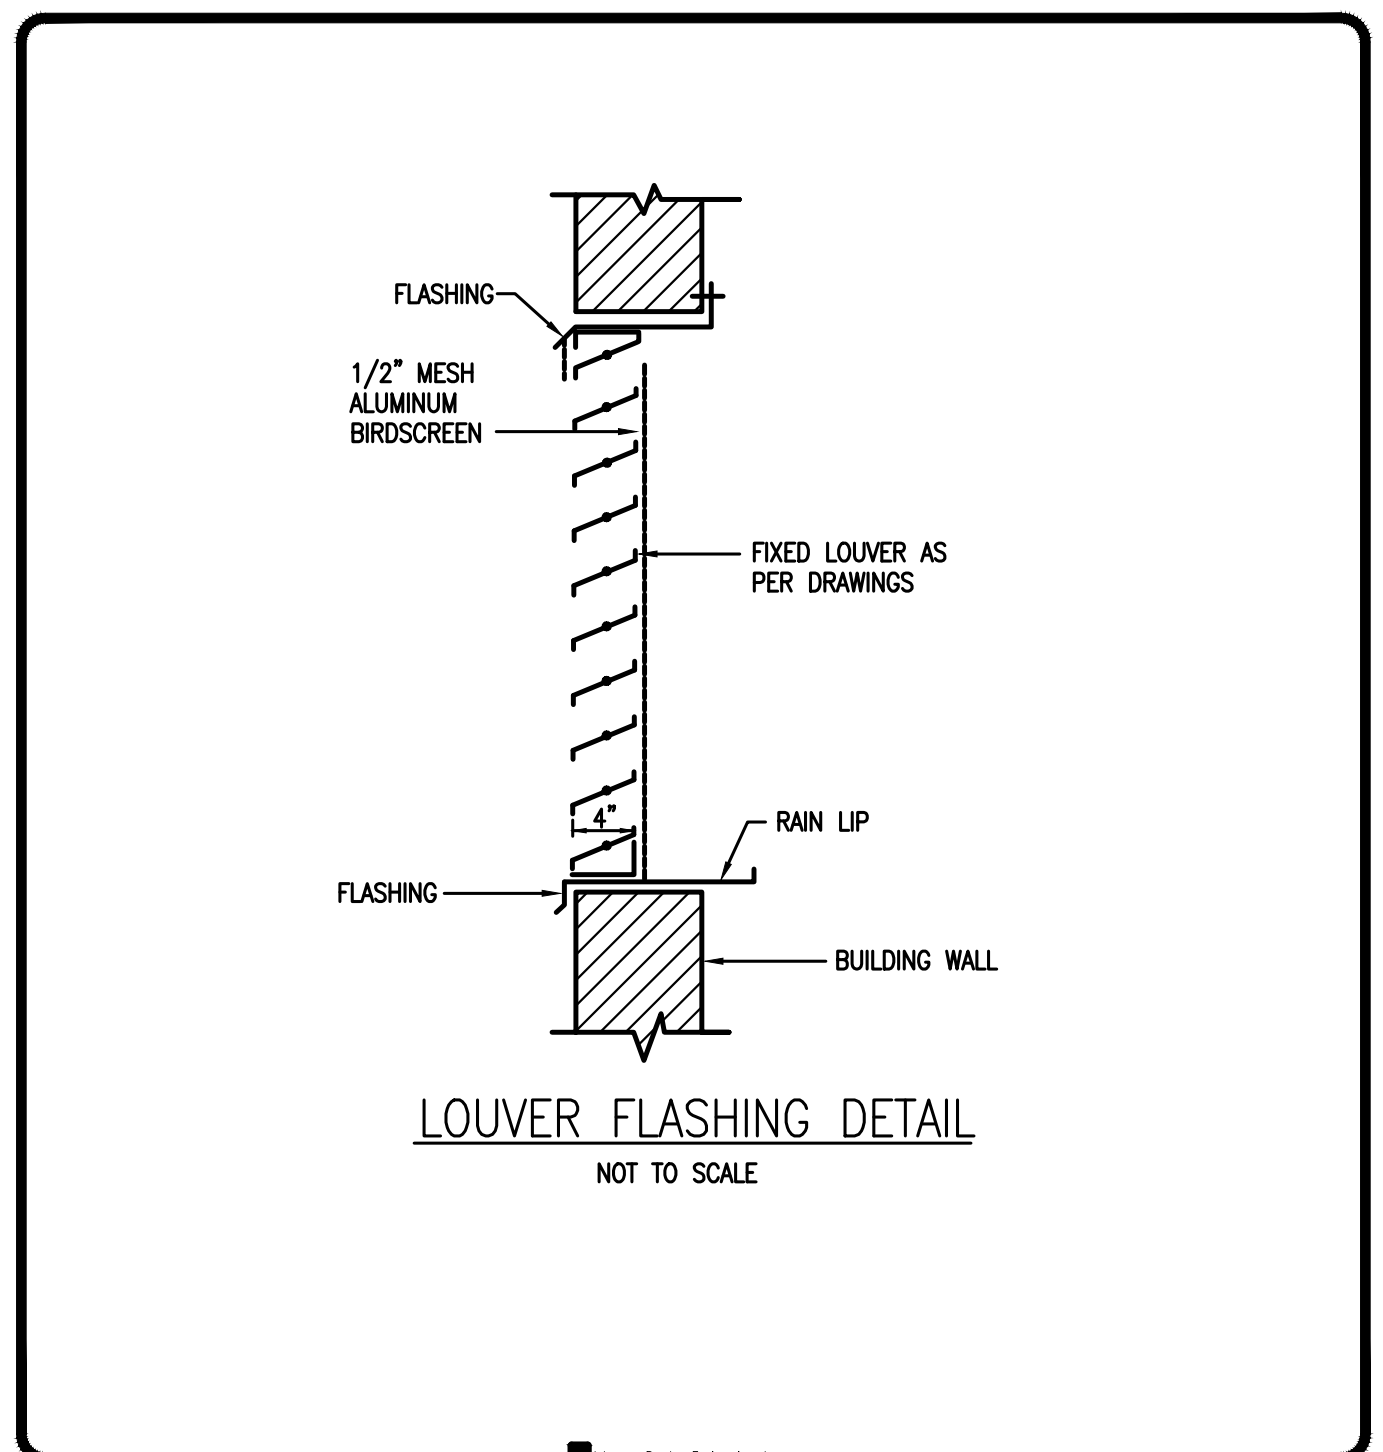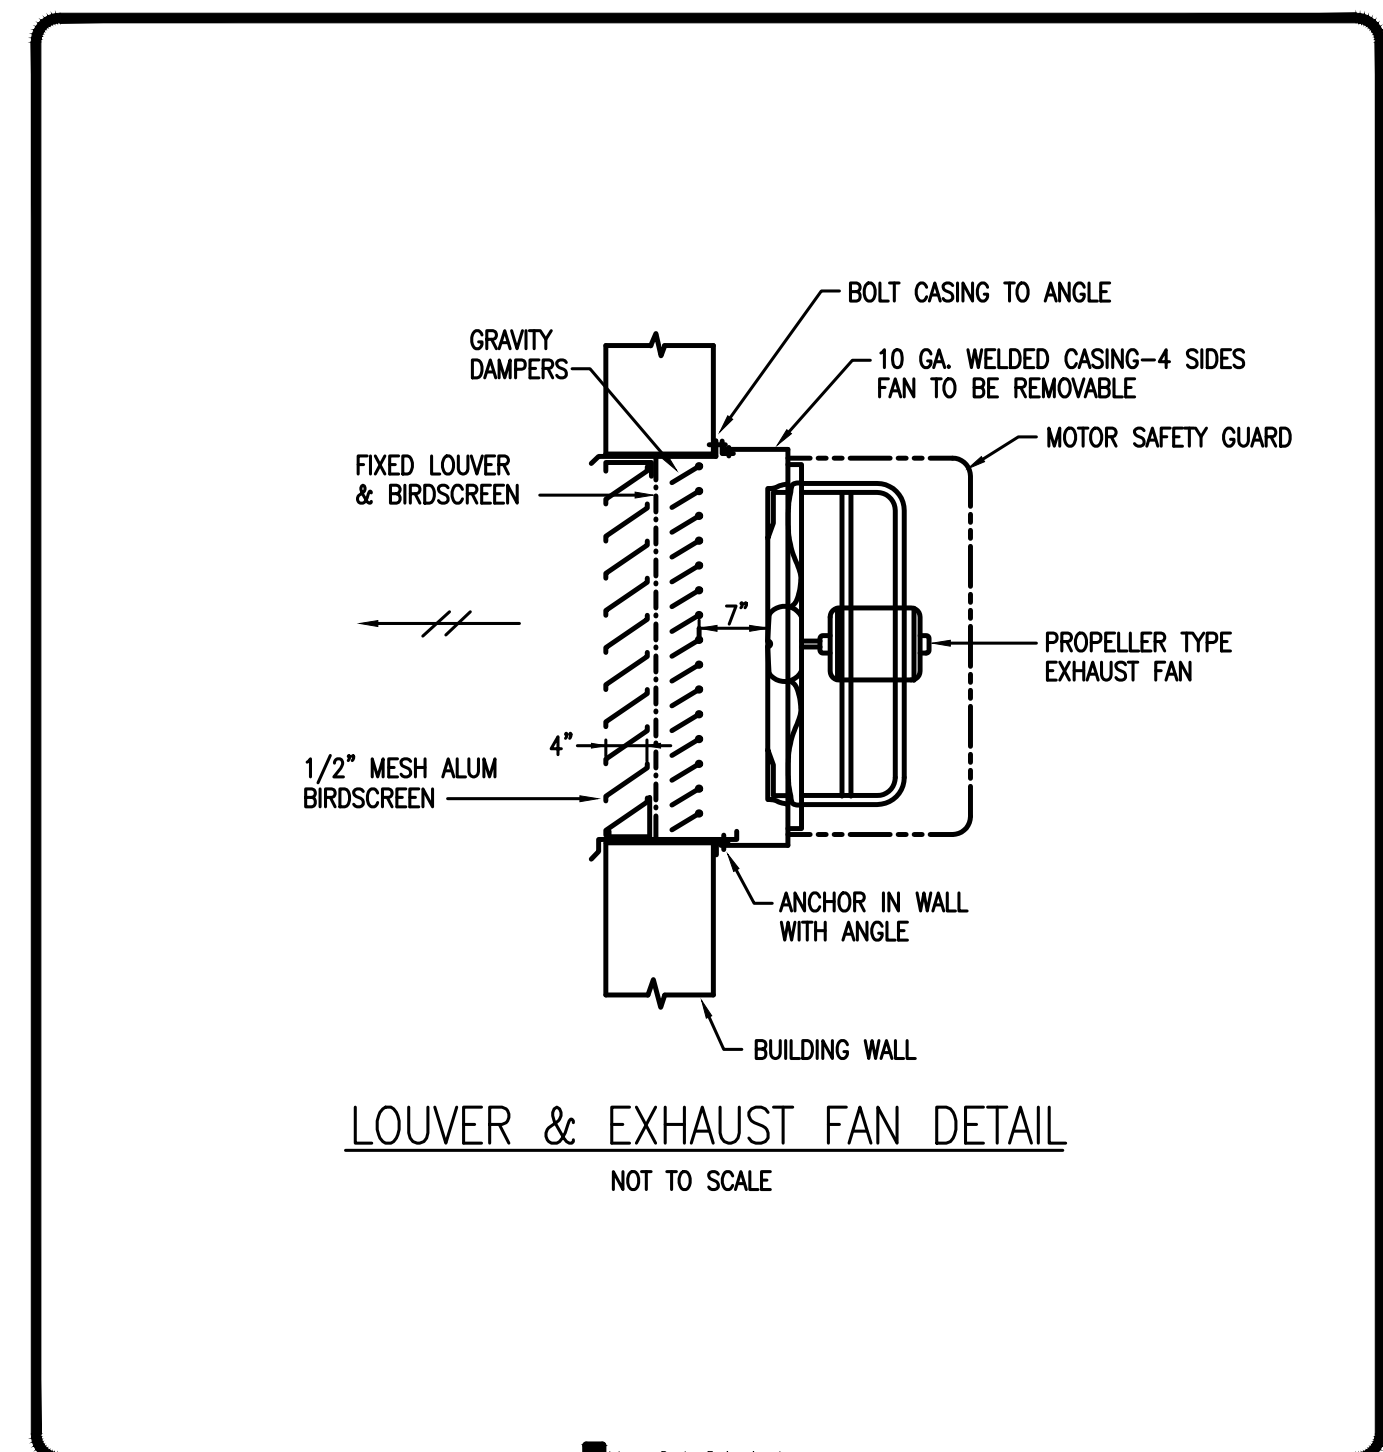


**7TH STREET BEACH RESTROOM  
 BUILDING**  
 HWY 98  
 MEXICO BEACH, FL 32410

**HVAC FLOOR PLAN,  
 NOTES AND DETAILS**


Rev. No.	Date	Remarks

Project Number: 2265  
 Date: 10-10-22  
 Designed By: JMP  
 Checked By: JWJ


These plans, ideas & concepts contained herein including any digital information are the sole property of Johnson, Peaden Engineering, Inc. They are not to be reproduced, copied, modified or changed without the express written permission and consent of Johnson, Peaden Engineering, Inc.

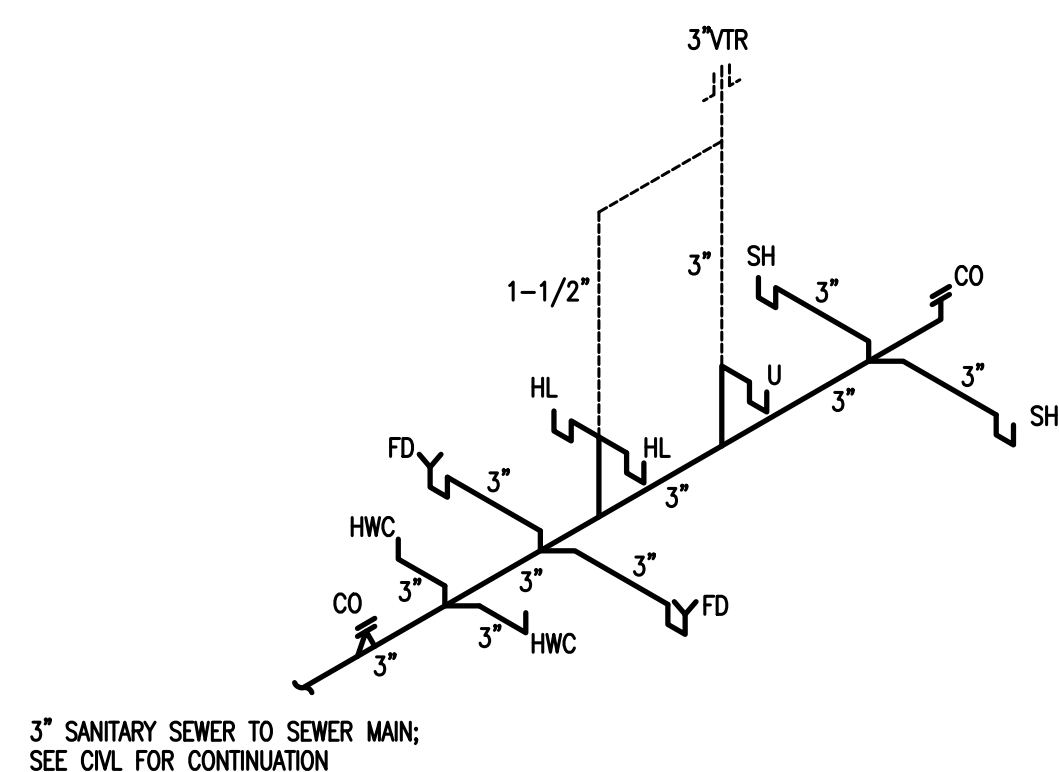


**SANITARY SEWER RISER**  
SCALE: NONE

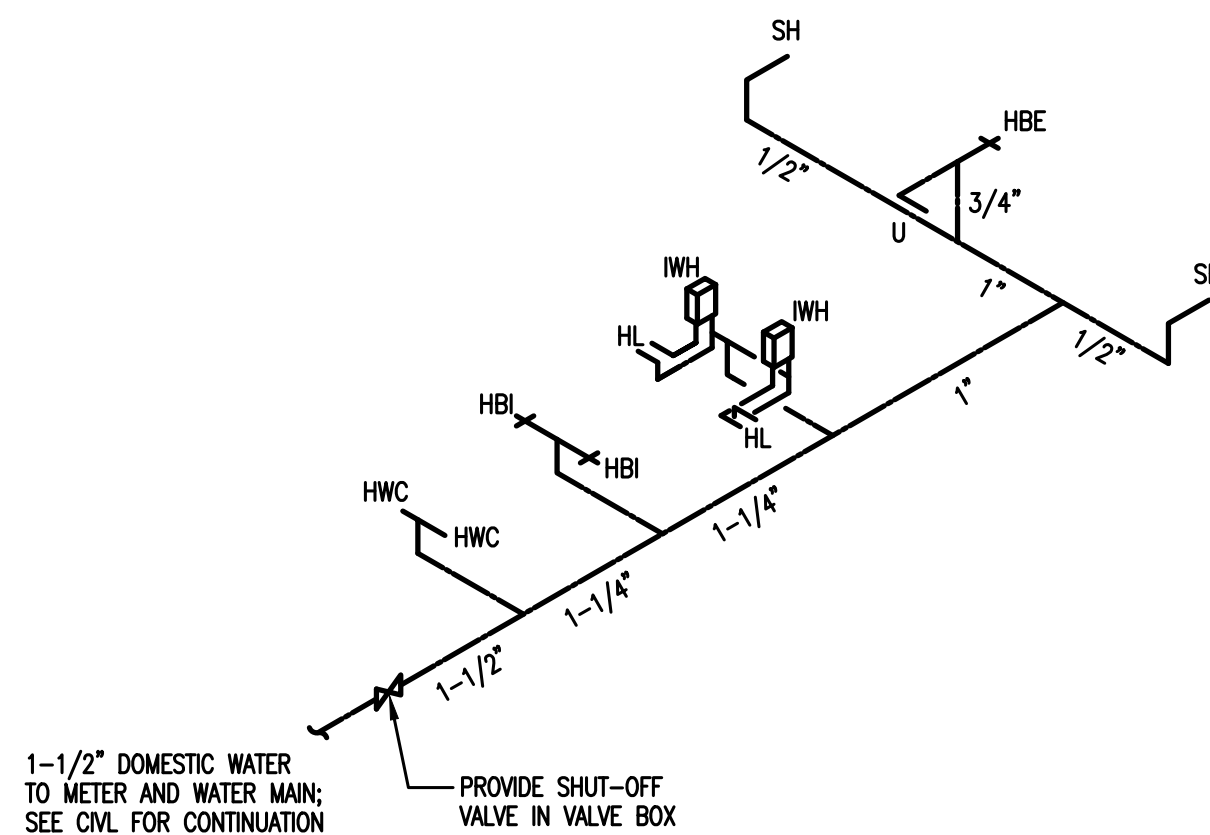


**DOMESTIC WATER RISER**  
SCALE: NONE

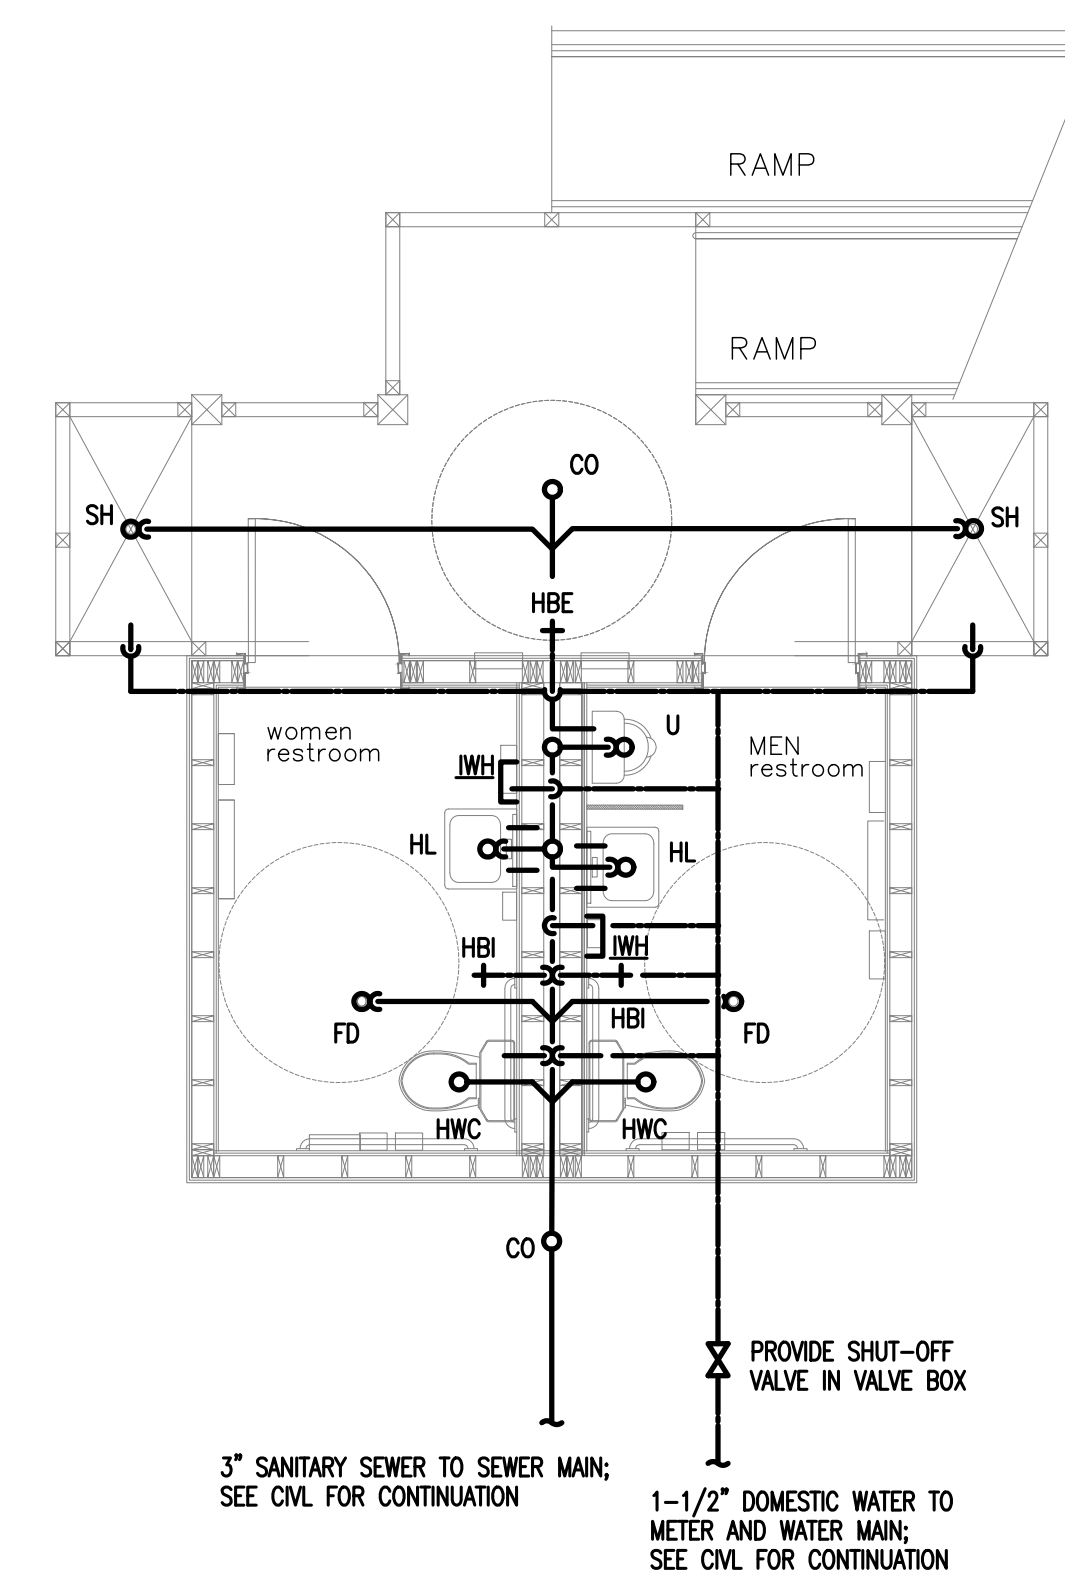


**PLUMBING FLOOR PLAN**  
SCALE: 1/4" = 1'-0"

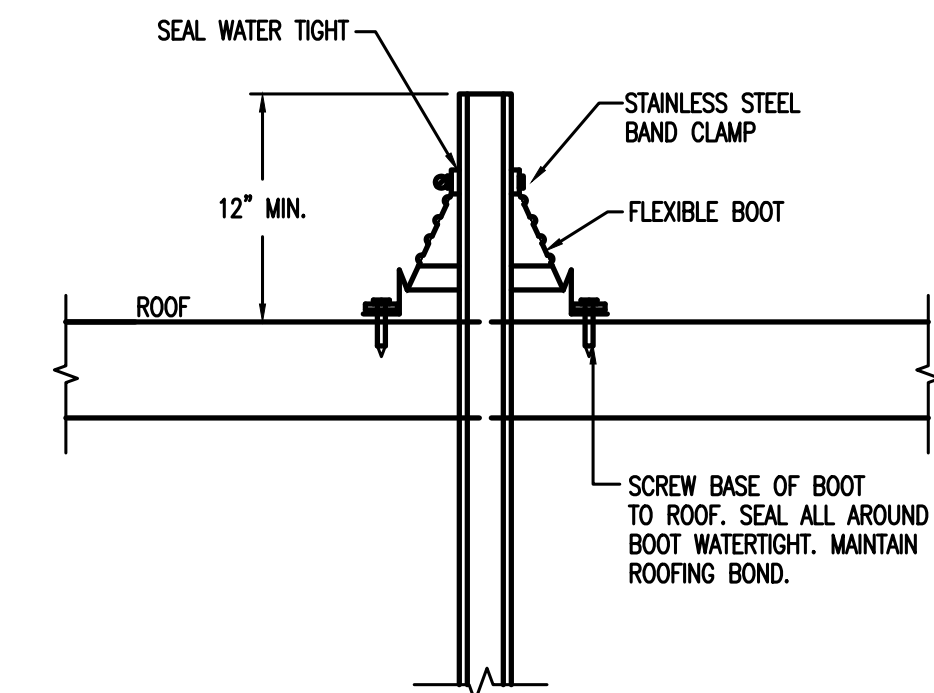

**VENT THROUGH ROOF DETAIL**  
NOT TO SCALE

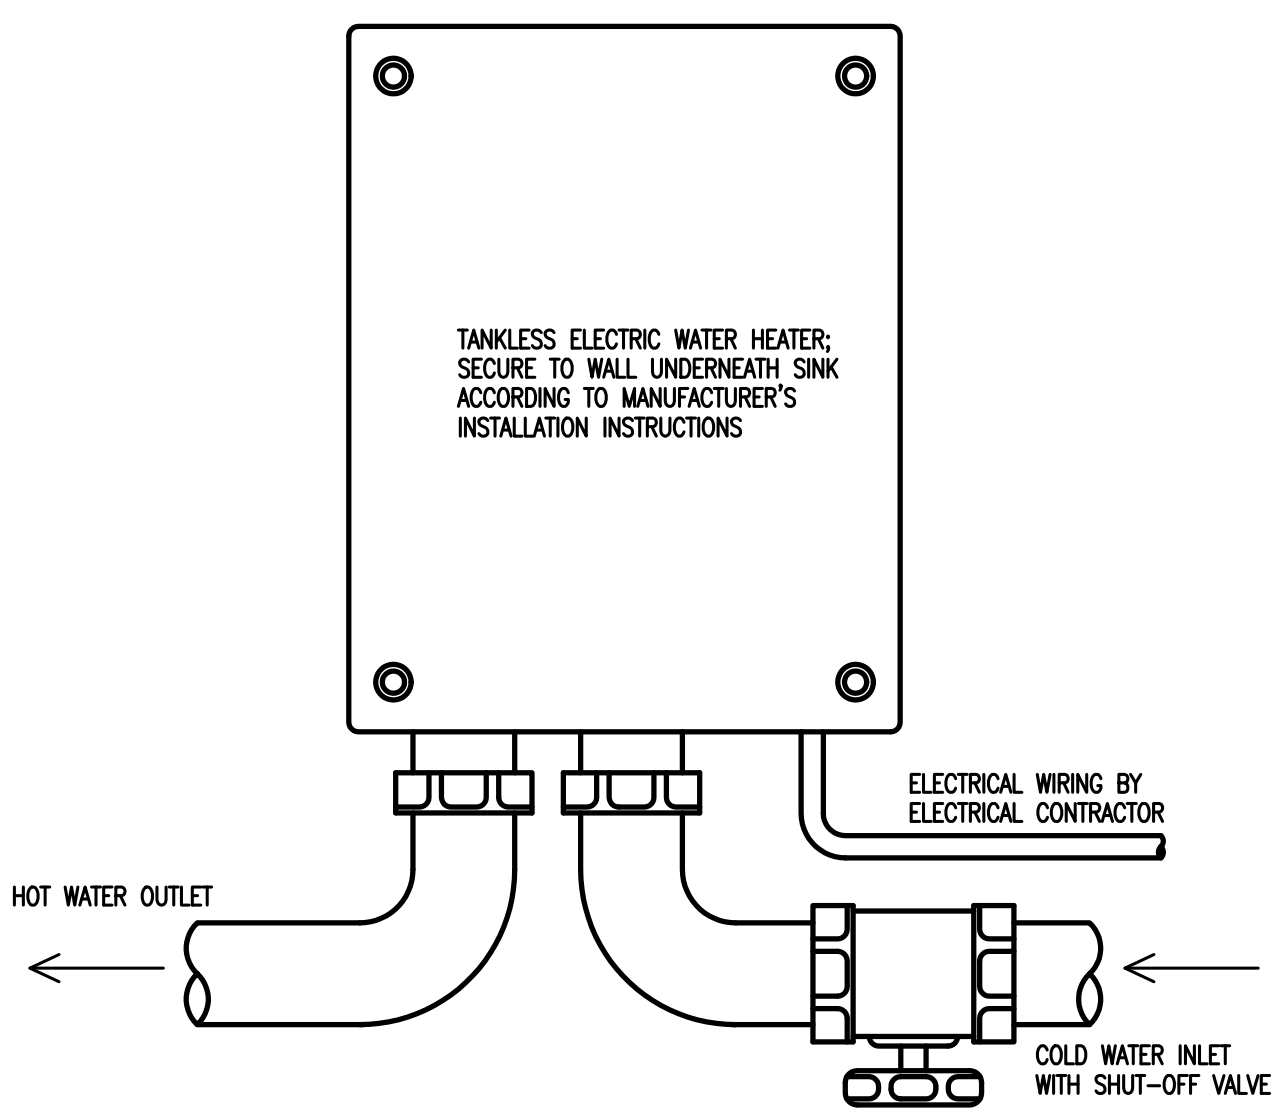


**TANKLESS ELECTRIC WATER HEATER DETAIL**  
NOT TO SCALE

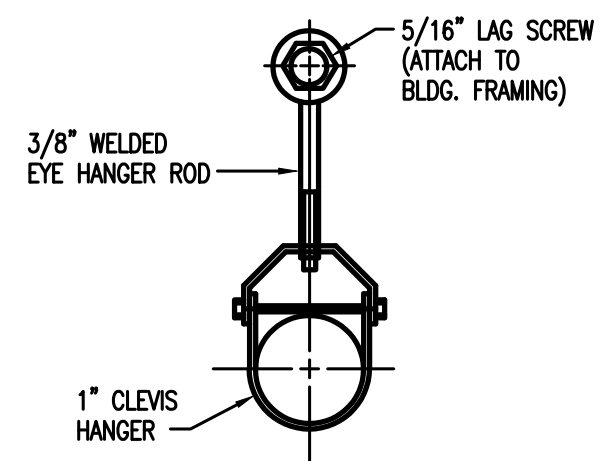


**HANGER DETAIL (TYPICAL)**  
NO SCALE

NOTE: USE APPROPRIATE HANGER AS APPROVED IN NFPA-13-A-3-15-1.

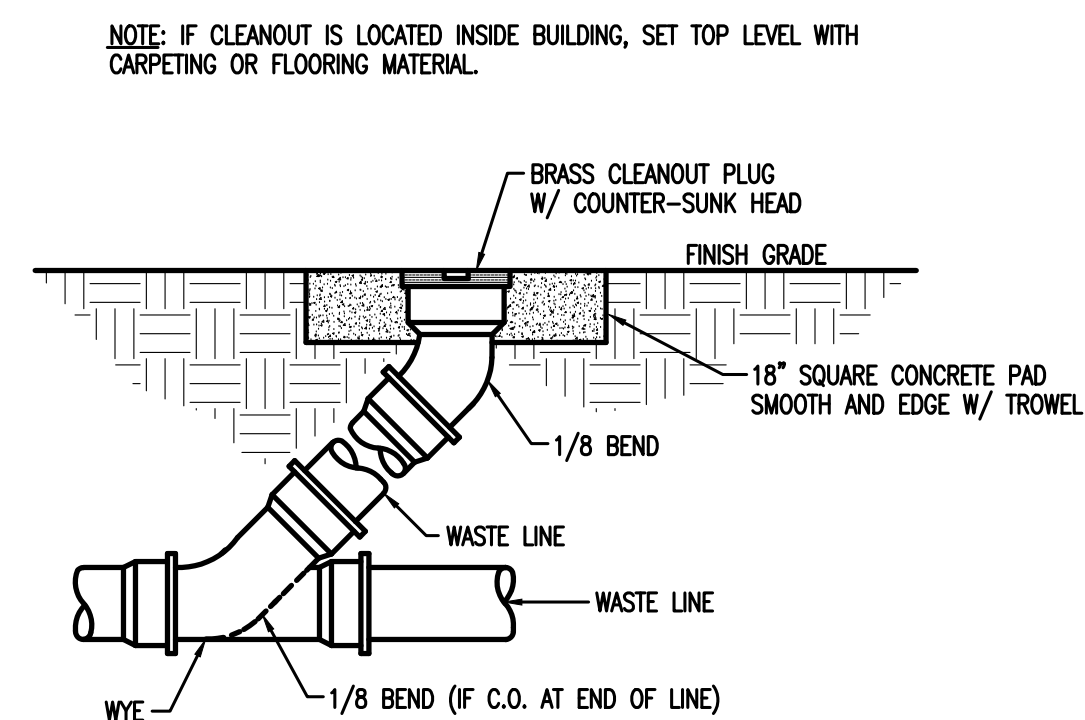


**CLEANOUT DETAIL**  
NOT TO SCALE

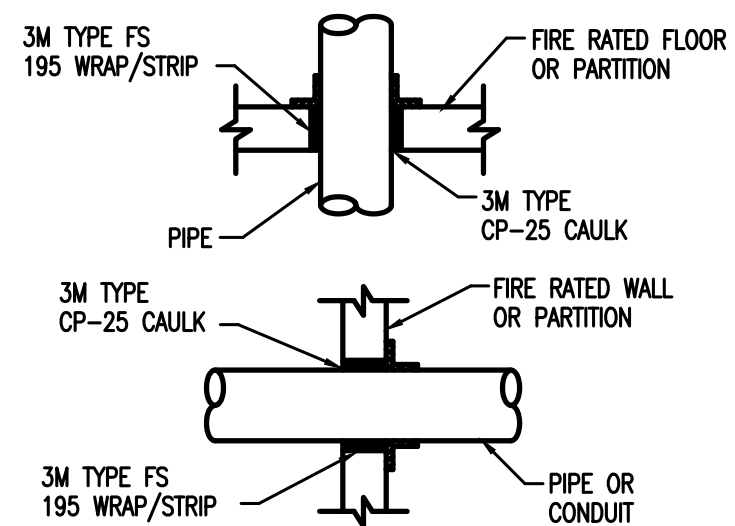

**FIRE STOPPING OF PIPING PENETRATIONS**  
NO SCALE

NOTE: ALL FIRE STOPPING MATERIAL TO COMPLY WITH STANDARD BUILDING CODE SECTION 705, ASTM E119 REQUIREMENTS.

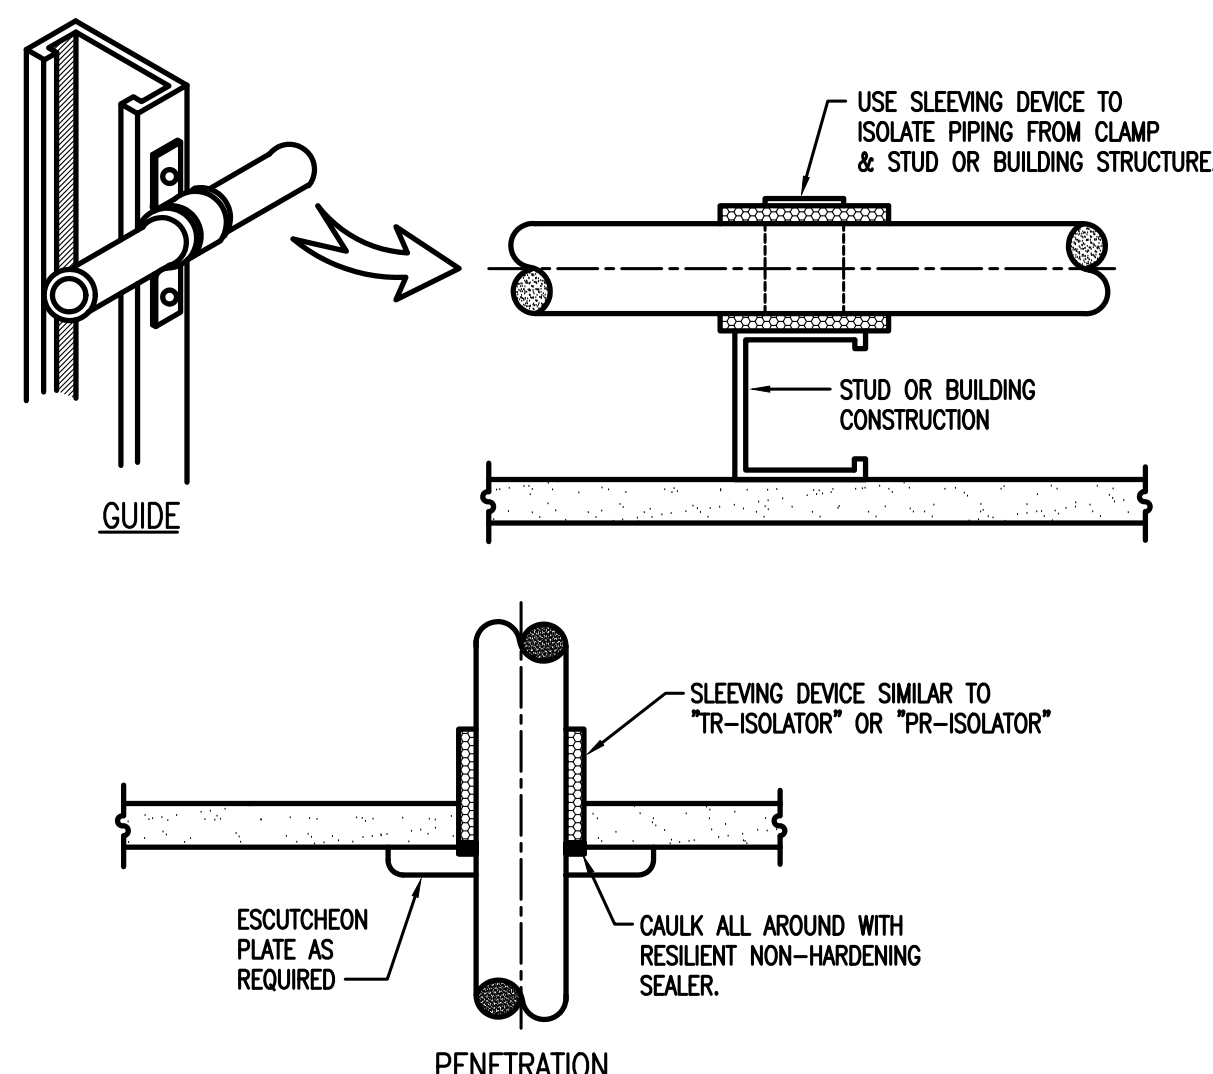

**DETAIL OF CONSTRUCTION PENETRATIONS & GUIDES FOR CONTROL OF PLUMBING NOISE & VIBRATION**  
NO SCALE

**GENERAL PLUMBING NOTES**

- FURNISH ALL LABOR, MATERIALS AND EQUIPMENT NEEDED TO PROVIDE A COMPLETE PLUMBING SYSTEM. THIS INCLUDES, BUT IS NOT LIMITED TO, WATER PIPING, WASTE AND VENT PIPING, AND ALL NECESSARY VALVES, TRAPS, AND ACCESSORIES.
- ALL WORK SHALL BE PERFORMED BY SKILLED AND EXPERIENCE WORKMEN. WORK SHALL COMPLY WITH ALL APPLICABLE STATE AND LOCAL CODES. THIS CONTRACTOR SHALL BE RESPONSIBLE FOR ALL REQUIRED PERMITS, LICENSES, AND INSPECTIONS.
- ROUGH-INS SHALL BE MADE FROM ARCHITECTURAL DRAWINGS AND FIELD VERIFICATION, NOT FROM PLUMBING DRAWINGS AS THEY ARE ONLY SCHEMATIC. THIS CONTRACTOR SHALL VERIFY ALL UTILITY LOCATIONS AND TAPS, AND FOR CHECKING ALL ELEVATIONS, GRADES, AND INVERTS BEFORE THE START OF CONSTRUCTION. IF UNSATISFACTORY CONDITIONS EXIST, NOTIFY THE ARCHITECT IMMEDIATELY.
- THIS CONTRACTOR SHALL COORDINATE ALL WORK WITH THE ELECTRICAL, MECHANICAL, AND FIRE PROTECTION CONTRACTORS TO AVOID CONFLICTS WITH OTHER TRADES. MAKE DEVIATIONS AS NECESSARY FROM THE WORK SHOWN ON THE DRAWINGS TO ENSURE THE WORK FITS THE SPACE(S) PROVIDED. NOTIFY THE ARCHITECT OF ALL NECESSARY DEVIATIONS.
- IF NEW CONNECTIONS REQUIRE INTERRUPTION OF EXISTING SERVICES, ALL PREPARATORY WORK SHALL BE COMPLETED EARLY TO MINIMIZE TIME. WHERE POSSIBLE, PROVIDE TEMPORARY CONNECTIONS TO MAINTAIN UTILITY SERVICE.
- ALL MATERIALS AND EQUIPMENT SHALL BE NEW AND WITHOUT DEFECTS. SUBMIT SHOP DRAWINGS FOR ALL EQUIPMENT AND MATERIALS. ALL WORK DONE BY THIS CONTRACTOR SHALL BE WARRANTED FOR ONE YEAR FROM THE TIME THE OWNER GIVES ACCEPTANCE OR GAINS BENEFICIAL USE, WHICHEVER IS FIRST.
- ALL SANITARY AND VENT LINES SHALL BE HUBLESS CAST IRON PIPE CISPI 310-78 STANDARD WEIGHT WITH SPIGOT ENDS FOR COUPLING. HUBLESS CAST IRON JOINTS TO BE CISPI 310 STAINLESS STEEL SHIELD OVER ONE PIECE NEOPRENE SLEEVE. THIS CONTRACTOR MAY USE PVC PIPE AND FITTINGS CONFORMING TO ASTM D-2665 WHERE ALLOWED BY CODE.
- ROOF PENETRATIONS SHALL BE FLASHED AND MADE WATER-TIGHT IN A MANNER APPROVED BY THE MANUFACTURER OF THE ROOFING MATERIAL AND COMPLYING WITH ARCHITECTURAL REQUIREMENTS.
- PROVIDE CLEANOUTS WHERE INDICATED ON PLANS AND AS NECESSARY TO COMPLY WITH THE STANDARD PLUMBING CODE. ALL CLEANOUTS SHALL BE IN ACCESSIBLE LOCATIONS.
- INSULATE ALL DOMESTIC WATER PIPING ABOVE GRADE WITH 3/4" THICK FLEXIBLE CLOSED-CELL POLYETHYLENE INSULATION. SEAL ALL JOINTS AND SEAMS AND INSULATE FITTINGS IN ACCORDANCE WITH THE MANUFACTURER'S INSTRUCTIONS.
- HANGERS FOR EQUIPMENT AND PIPING SHALL BE SECURED TO THE BUILDING STRUCTURE. NO HANGERS SHALL BE ATTACHED TO THE FLOOR OR ROOF DECK MATERIAL, OR CONCRETE DECKS LESS THAN 4" THICK.
- INSTALL SHOCK ABSORBERS VERTICALLY AT EACH FIXTURE. OFFSET AS NEEDED TO GAIN A MINIMUM HEIGHT OF 18". ALL SHOCK ABSORBERS SHALL BE A MINIMUM OF ONE PIPE SIZE LARGER THAN THE BRANCH BEING SERVED.
- PROVIDE CHROME PLATED BRASS ESCUTCHEON PLATES AT ALL PENETRATIONS OF WALLS, FLOORS OR CEILINGS IN FINISHED AREAS AND UNDER LAVATORIES. PROVIDE STOPS AND TRAPS FOR ALL FIXTURES. LEAK TEST WATER PIPING, FOR NOT LESS THAN 90 MINUTES AT 100 PSI. FILL SANITARY SEWER SYSTEM TO A MINIMUM HEIGHT OF TEN FEET AND LET STAND FOR AT LEAST 30 MINUTES WITHOUT LEAKAGE. AFTER PRESSURE TESTS HAVE BEEN MADE, THOROUGHLY FLUSH THE ENTIRE DOMESTIC WATER SYSTEM WITH WATER UNTIL ALL ENTRAINED DIRT AND MUD HAVE BEEN REMOVED, AND STERILIZE. THE STERILIZING MATERIAL SHALL BE EITHER LIQUID CHLORINE CONFORMING THE FED. SPEC. BB-C-120, OR HYPOCHLORITE CONFORMING TO FED. SPEC. 0-C-114, OR FED. SPEC. 0-5-602M. THE CHLORINATING AGENT SHALL PROVIDE A MINIMUM DOSAGE OF 50 PPM AND SHALL BE RETAINED IN THE SYSTEM FOR 90 MIN. THE SYSTEM WILL THEN BE FLUSHED WITH CLEAN POTABLE WATER UNTIL THE RESIDUAL CHLORINE IS REDUCED TO LESS THAN 1.0 PPM. HAVE THREE STATE-APPROVED INDEPENDENT TESTING FACILITIES TAKE SAMPLES AND DELIVER CERTIFICATES OF APPROVAL TO THE OWNER. ANY NEGATIVE RESULTS MUST BE INVESTIGATED, AND IF NECESSARY CORRECTED, BEFORE THE BUILDING MAY BE ACCEPTED.

**PLUMBING FIXTURE SCHEDULE**

MARK	FIXTURE	SANITARY	C.W.	H.W.
HWC	WATER CLOSET, FLOOR, FLUSH VALVE, ADA COMPLIANT	3"	1-1/4"	-
HL	LAVATORY, WALL-HUNG WITH CARRIER, ADA COMPLIANT	1 1/4"	1/2"	1/2"
U	URINAL, WALL-HUNG WITH CARRIER	2"	3/4"	-
CO	CLEAN OUT WITH BRONZE PLUG	ON DWG	-	-
FD	FLOOR DRAIN W/ TRAP PRIMER	3"	-	-
HBE	HOSE BIBB, FREEZEPROOF, KEYED, EXTERIOR WALL BOX	-	1/2"	-
HBE	HOSE BIBB, FREEZEPROOF, KEYED, INTERIOR	-	3/4"	-
WH	TANKLESS ELECTRIC WATER HEATER, 4.16 kW ELEMENT, 208v	T&P	3/4"	3/4"
	EQUAL TO CHROMIUM CM-20L WITH ADJUSTABLE SET POINT			


**7TH STREET BEACH RESTROOM  
BUILDING**  
HWY 98  
MEXICO BEACH, FL 32410

**PLUMBING FLOOR PLAN,  
NOTES AND DETAILS**

Rev. No.	Date	Remarks

Project Number: 2265  
Date: 10-10-22  
Designed By: JMP  
Checked By: JWJ



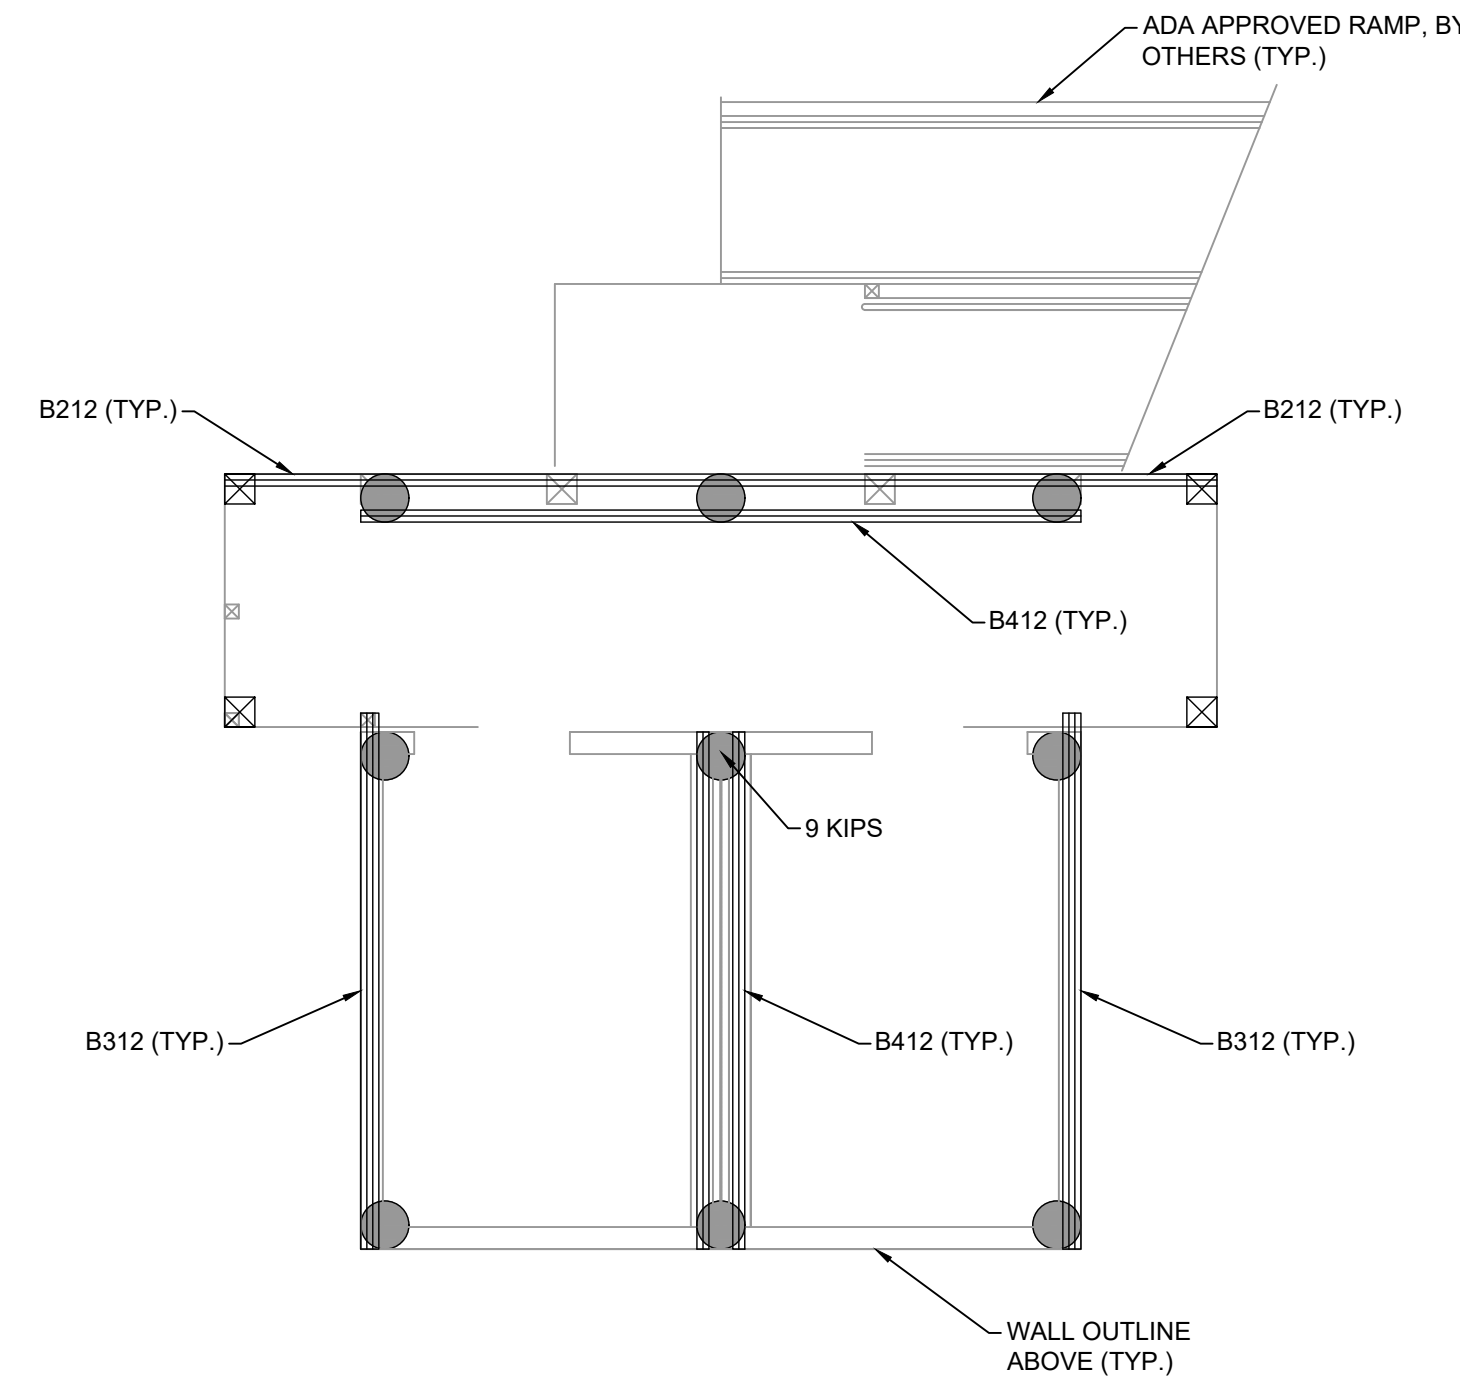


**1**  
**S1** PILING & GIRDER PLAN

SCALE: 1/2" = 1'-0"

**PILING PLAN NOTES:**

- - INDICATES LOCATION OF 12" BUTT (10" TIP MIN.) TIMBER PILING (TYP. OF 9)
- XX KIPS - INDICATES FACTORED PILE LOADS

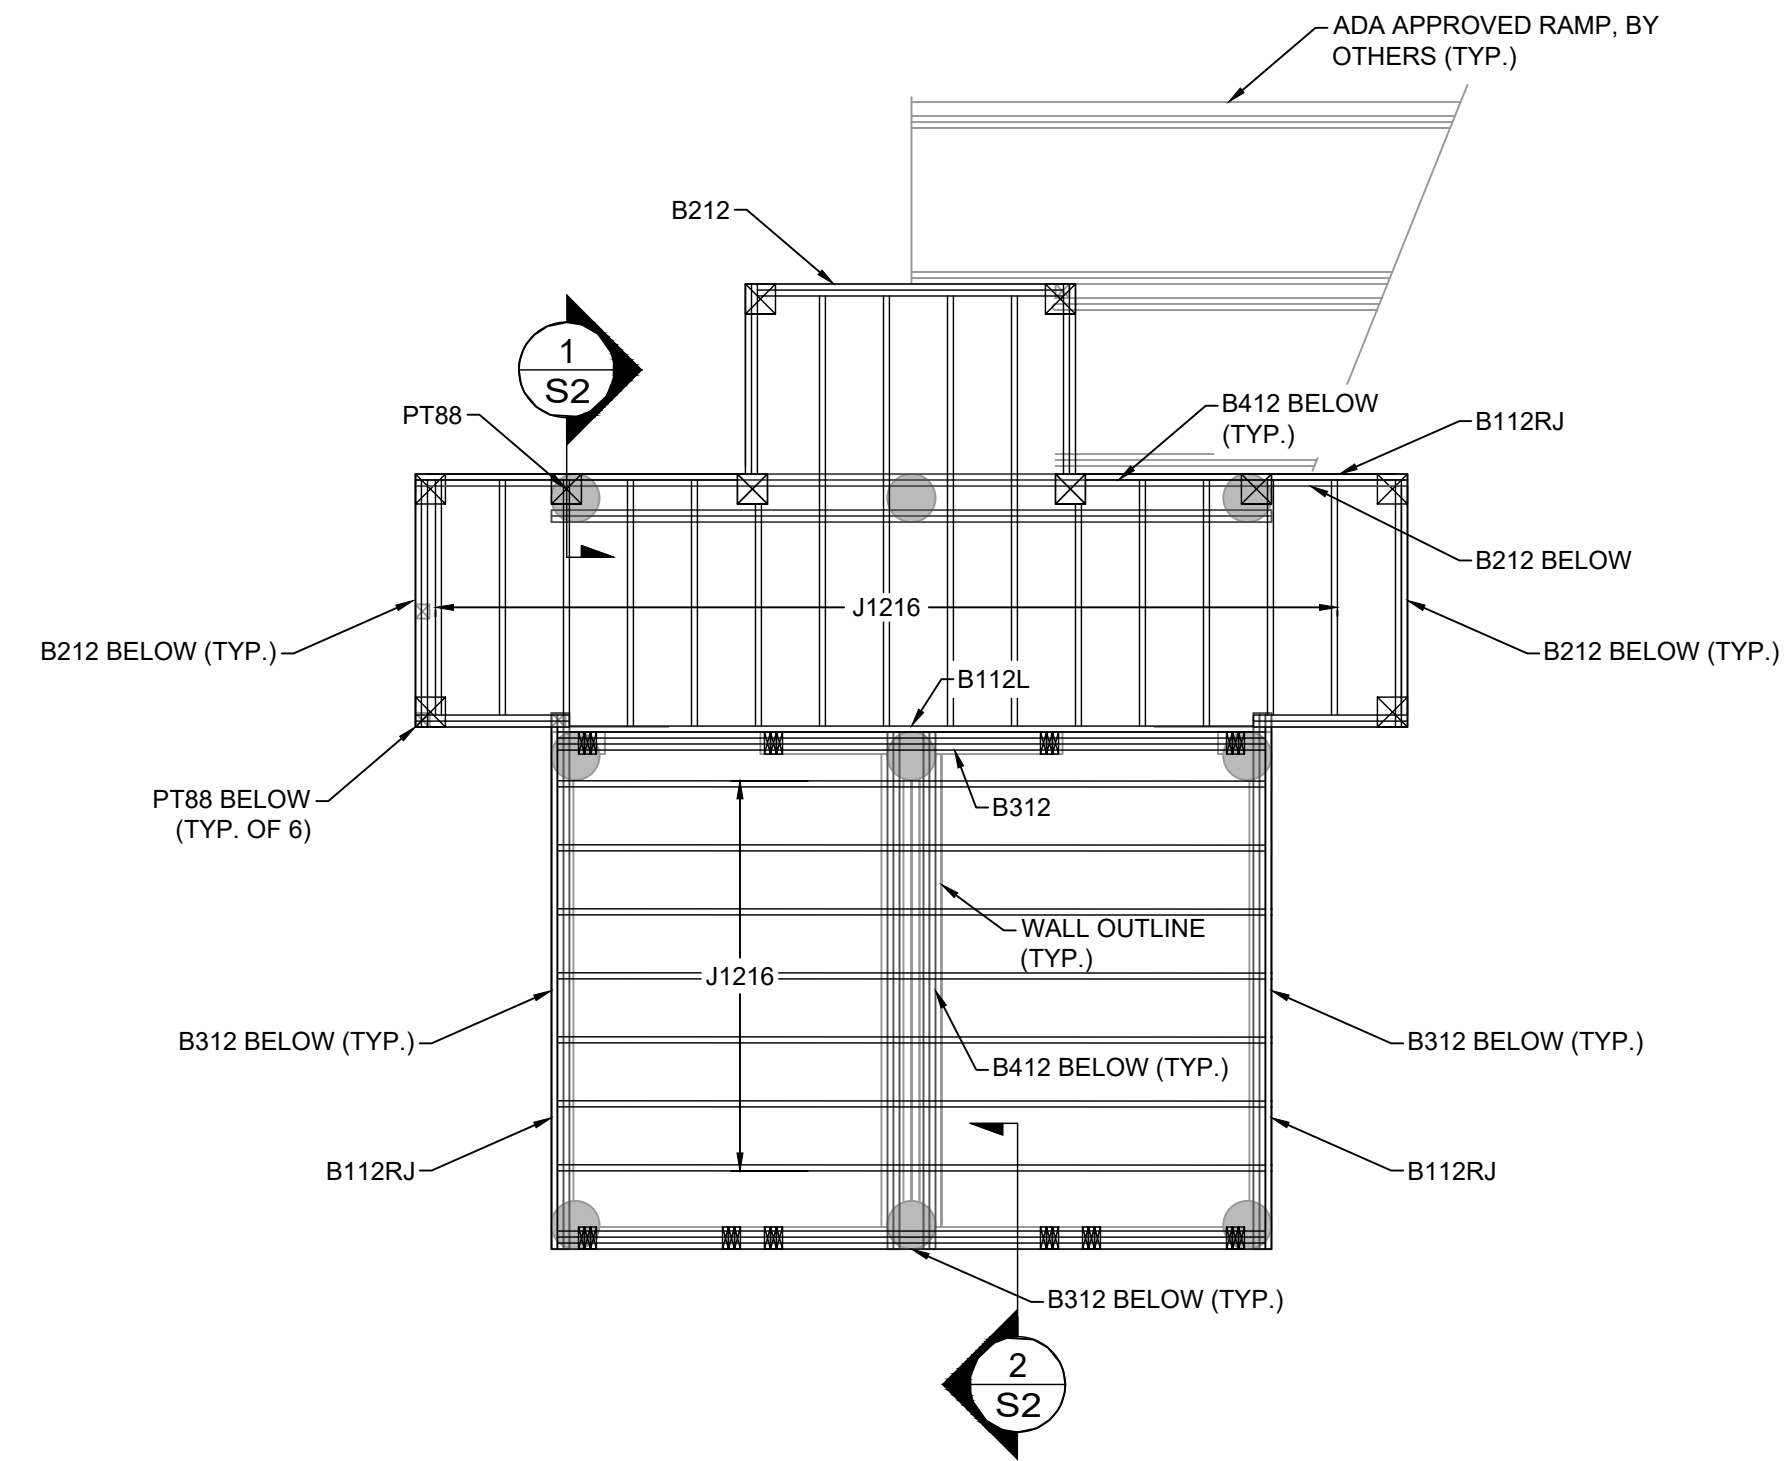


**2**  
**S1** FIRST FLOOR FRAMING PLAN

SCALE: 1/4" = 1'-0"

**FRAMING PLAN NOTES:**

- INSTALL SIMPSON H2.5A @ ALL FLOOR JOISTS TO GIRDER CONNECTIONS (TYP.)
- - INDICATES LOCATION OF TIMBER PILE BELOW
- - INDICATES LOCATION OF TRIPLE STUD PACK. ATTACH TO GIRDER BELOW USING (2) SIMPSON MSTA24

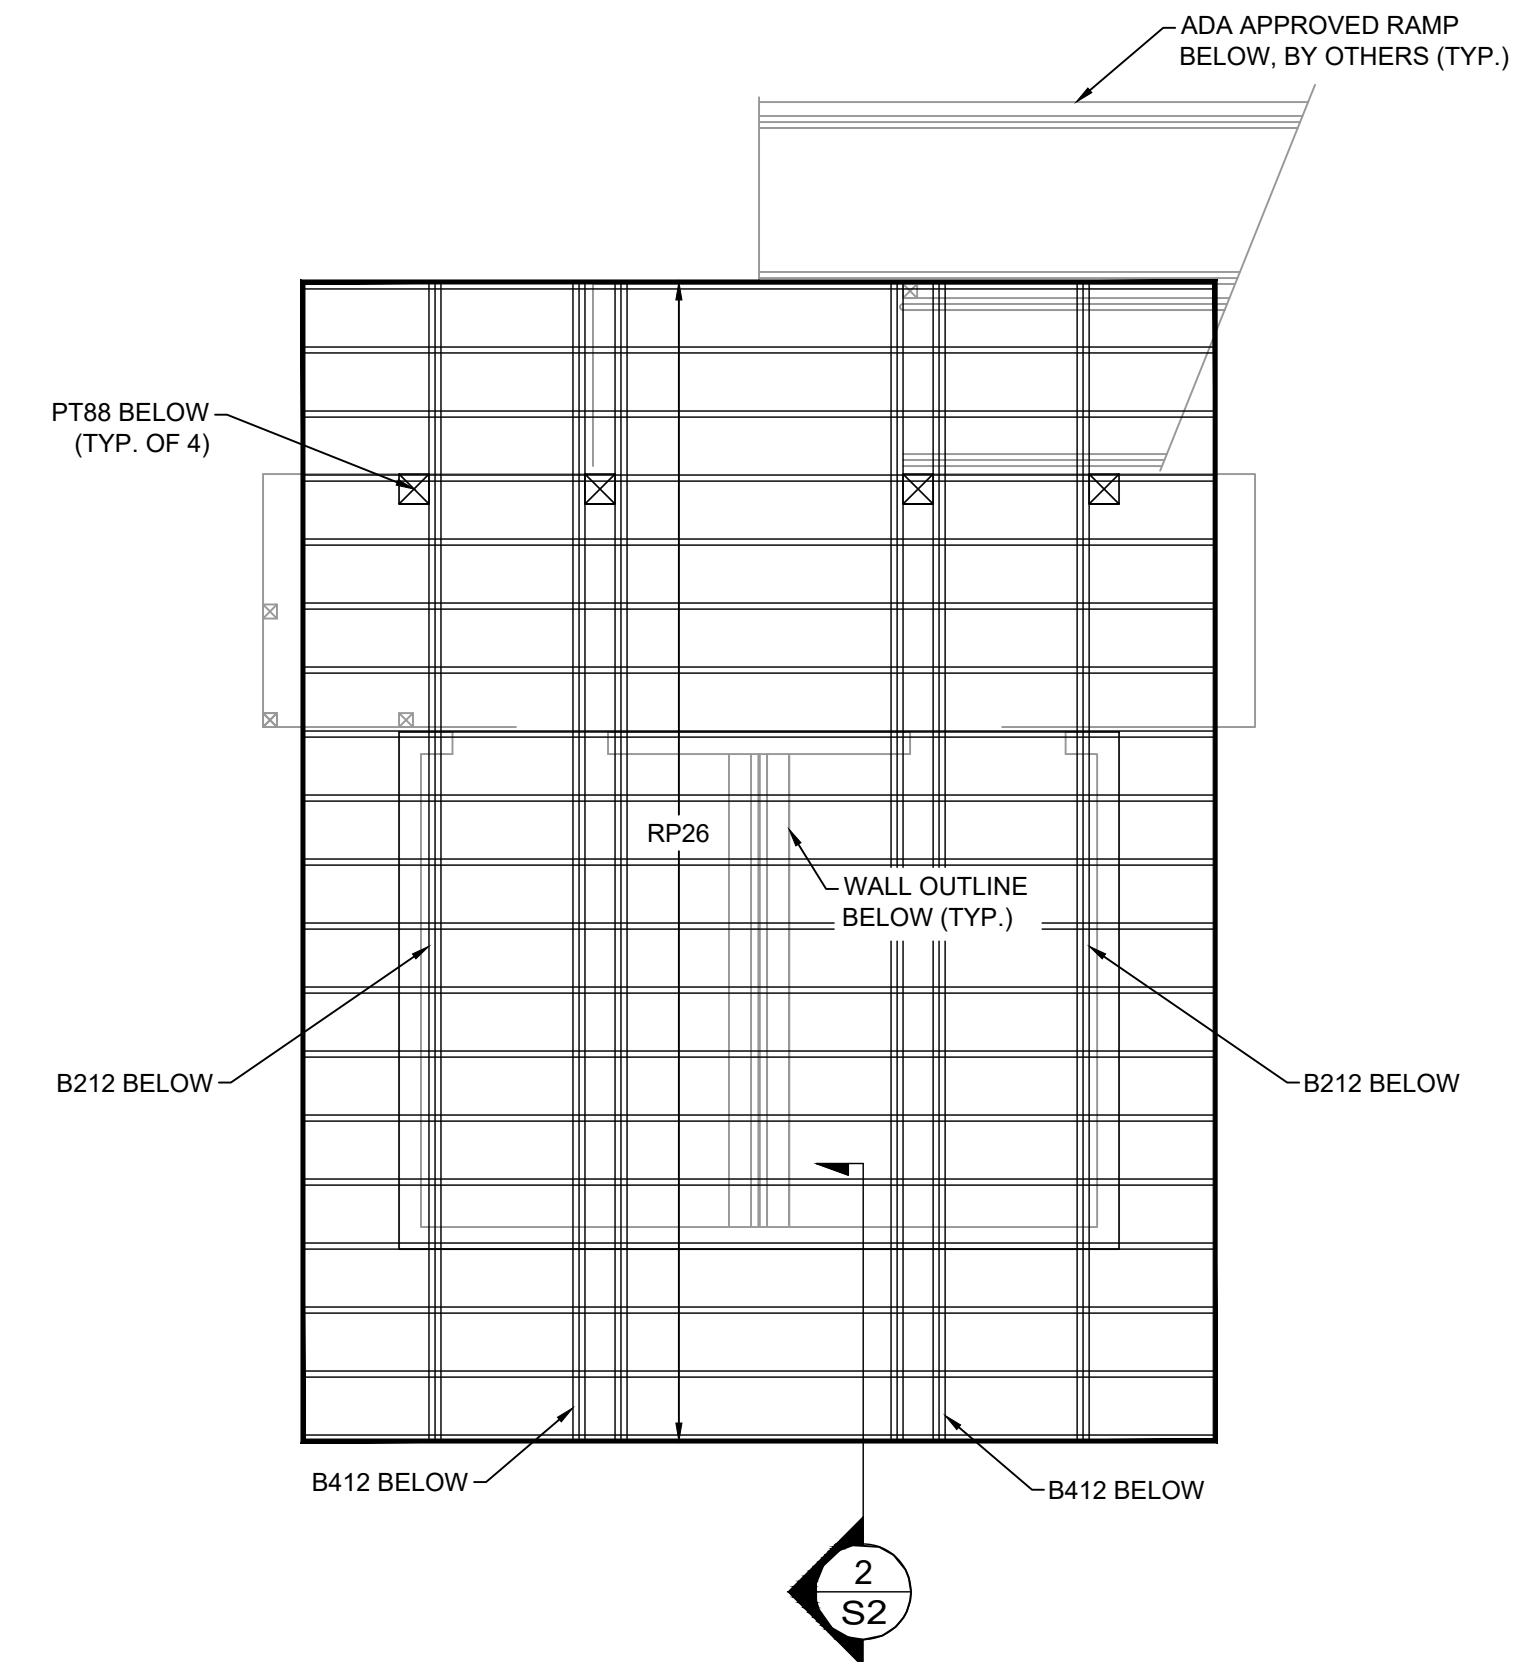

**3**  
**S1** ROOF FRAMING PLAN

SCALE: 1/2" = 1'-0"

**FRAMING PLAN NOTES:**

- ATTACH ALL ROOF PURLINS ROOF BEAMS USING SIMPSON H2.5A HURRICANE TIES @ EACH INTERSECTION.
- ATTACH ROOF BEAMS TO TOP PLATE AND STUD PACK USING SIMPSON MST20 @ TOP PLATE/STUD PACK CONNECTIONS. CONNECT TO POSTS USING (2) 5/8" THRU BOLTS. ATTACH STUD PACKS & KING STUDS TO FRAMING BELOW w/ (2) SIMPSON MSTA24

**PRELIMINARY  
FOR BIDDING  
PURPOSES ONLY**

FRAMING LEGEND	
RP26	2 X 6 (MIN.) P.T. #2 S.P. ROOF PURLINS @ 16" O.C. SEE DETAILS FOR CONNECTIONS
B412	(4) 2 X 12 P.T. #2 S.P. BEAM (2 ON EACH SIDE OF POST) CONN. TO PILE/POST w/ (2) 5/8" THRU BOLTS
B312	(3) 2 X 12 P.T. #2 S.P. CONNECT PILE USING (2) 5/8" THRU BOLTS
B212	(2) 2 X 12 P.T. #2 S.P. BEAM, WHERE APPLICABLE INSTALL SIMPSON HUC210-2 @ HUNG CONN.
B112RJ	2 X 12 P.T. #2 S.P. RIM JOIST w/ (5) 12D NAILS @ EACH JOIST CONNECTION
J1216	2 X 12 P.T. #2 S.P. JOIST @ 16" O.C. (MAX.) w/ SIMPSON LUS210 @ HUNG CONN. & H2.5A @ BEARING CONN.
B112L	2 X 12 P.T. #2 S.P. LEDGER w/ 1/2" X 5" LAG SCREWS STAGGERED @ TOP & BOTTOM @ 16" O.C. (MUST PENETRATE FRAMING BEYOND)
PT88	8 X 8 P.T. #2 S.P. POST, POST SHALL BE NOTCHED & BOLTED TO BEAMPILE USING (2) 5/8" THRU BOLTS

**STRUCTURAL PLANS**

**7TH STREET BEACH RESTROOM BUILDING  
HWY 98  
MEXICO BEACH, FLORIDA 32410**


PROJECT NUMBER: 21-167-14

DESIGNED BY: H.BAUMGARDNER  
DRAWN BY: S.GALARESO  
CHECKED BY: J.HUSBAND


FOR: CITY OF MEXICO BEACH  
PARADISE PALMS  
MEXICO BEACH, FL 32456

DATE: 09/30/22  
SHEET NO.

**PRELIMINARY  
FOR BIDDING  
PURPOSES ONLY**

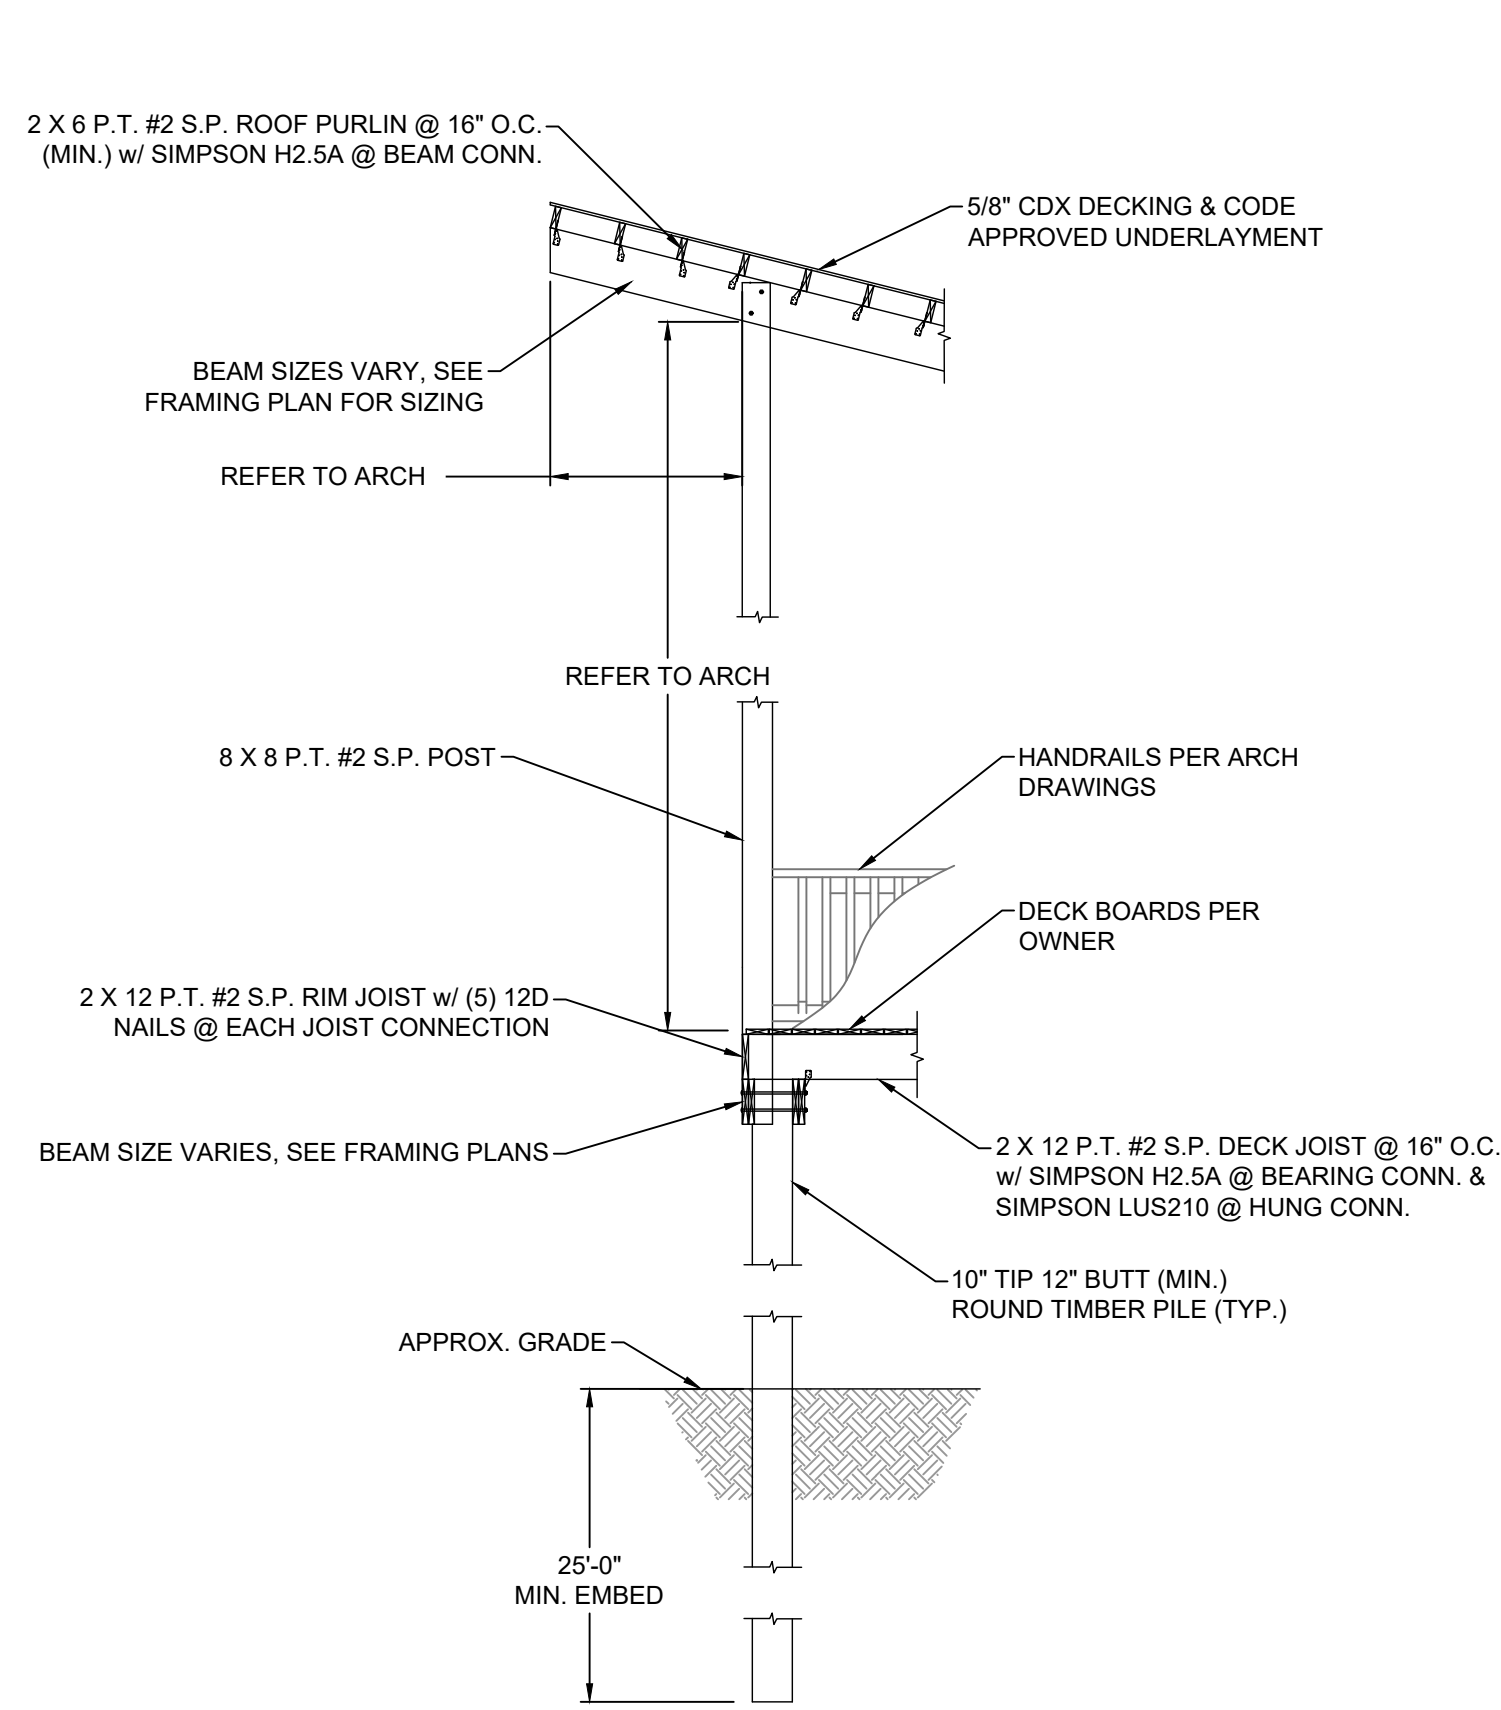


**1**  
**S2** TYP. PORCH SECTION  
SCALE: N.T.S.

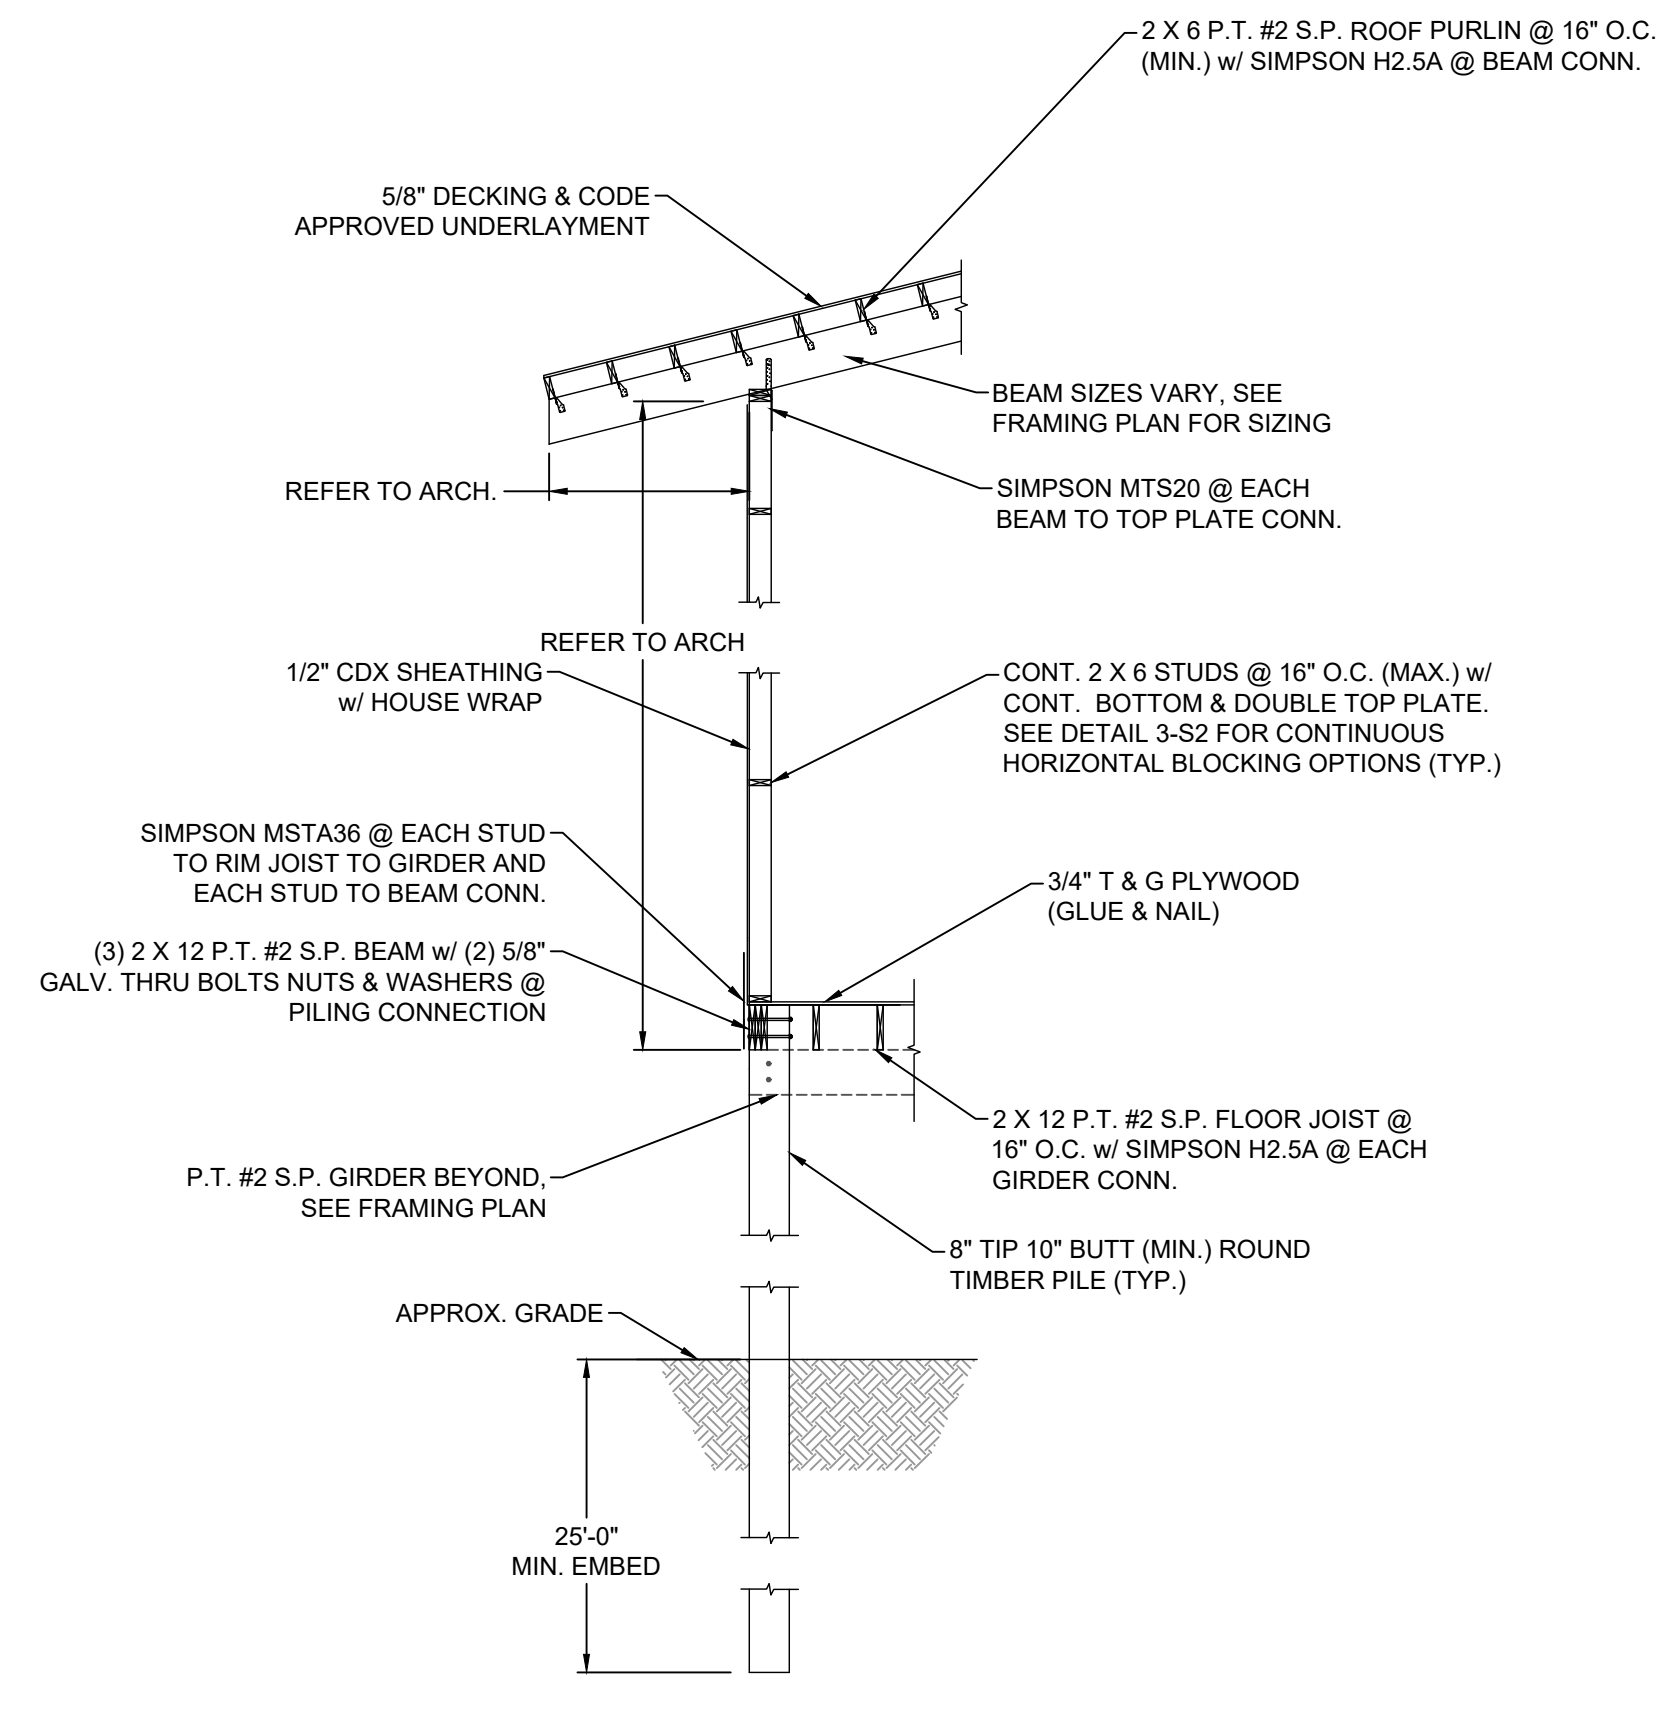


**2**  
**S2** TYP. EXT. WALL SECTION  
SCALE: N.T.S.

- NOTES:
1. DOOR OPENINGS SHALL BE BUILT IN THE SAME MANNER AS THE WINDOW OPENING FRAMING SHOWN WITH THE EXCEPTION OF THE BOTTOM SILL AND CRIPPLES.
  2. ALL HEADERS SHALL BE BUILT AS SPECIFIED IN THIS DETAIL UNLESS OTHERWISE NOTED ON FRAMING PLAN.

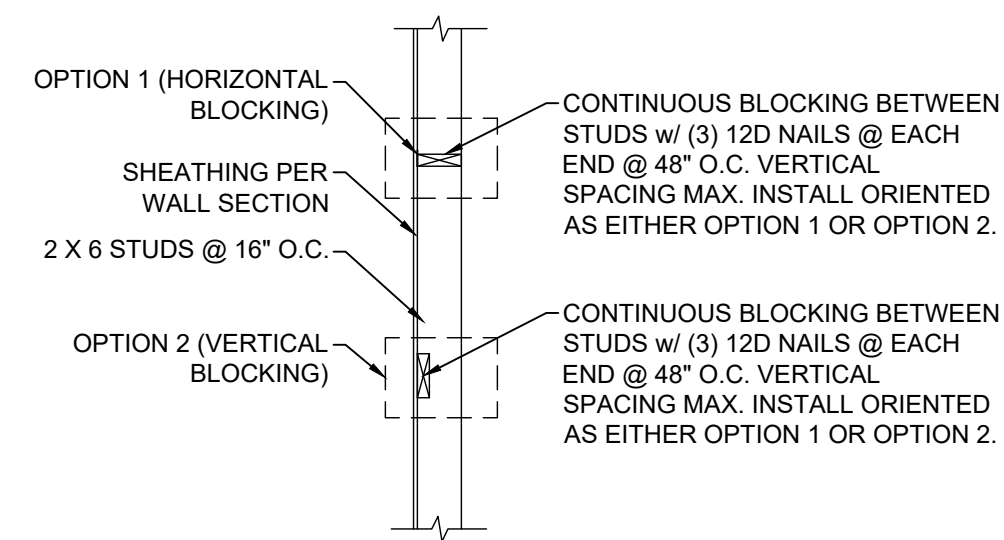

**3**  
**S2** STUD BLOCKING OPTIONS  
SCALE: N.T.S.

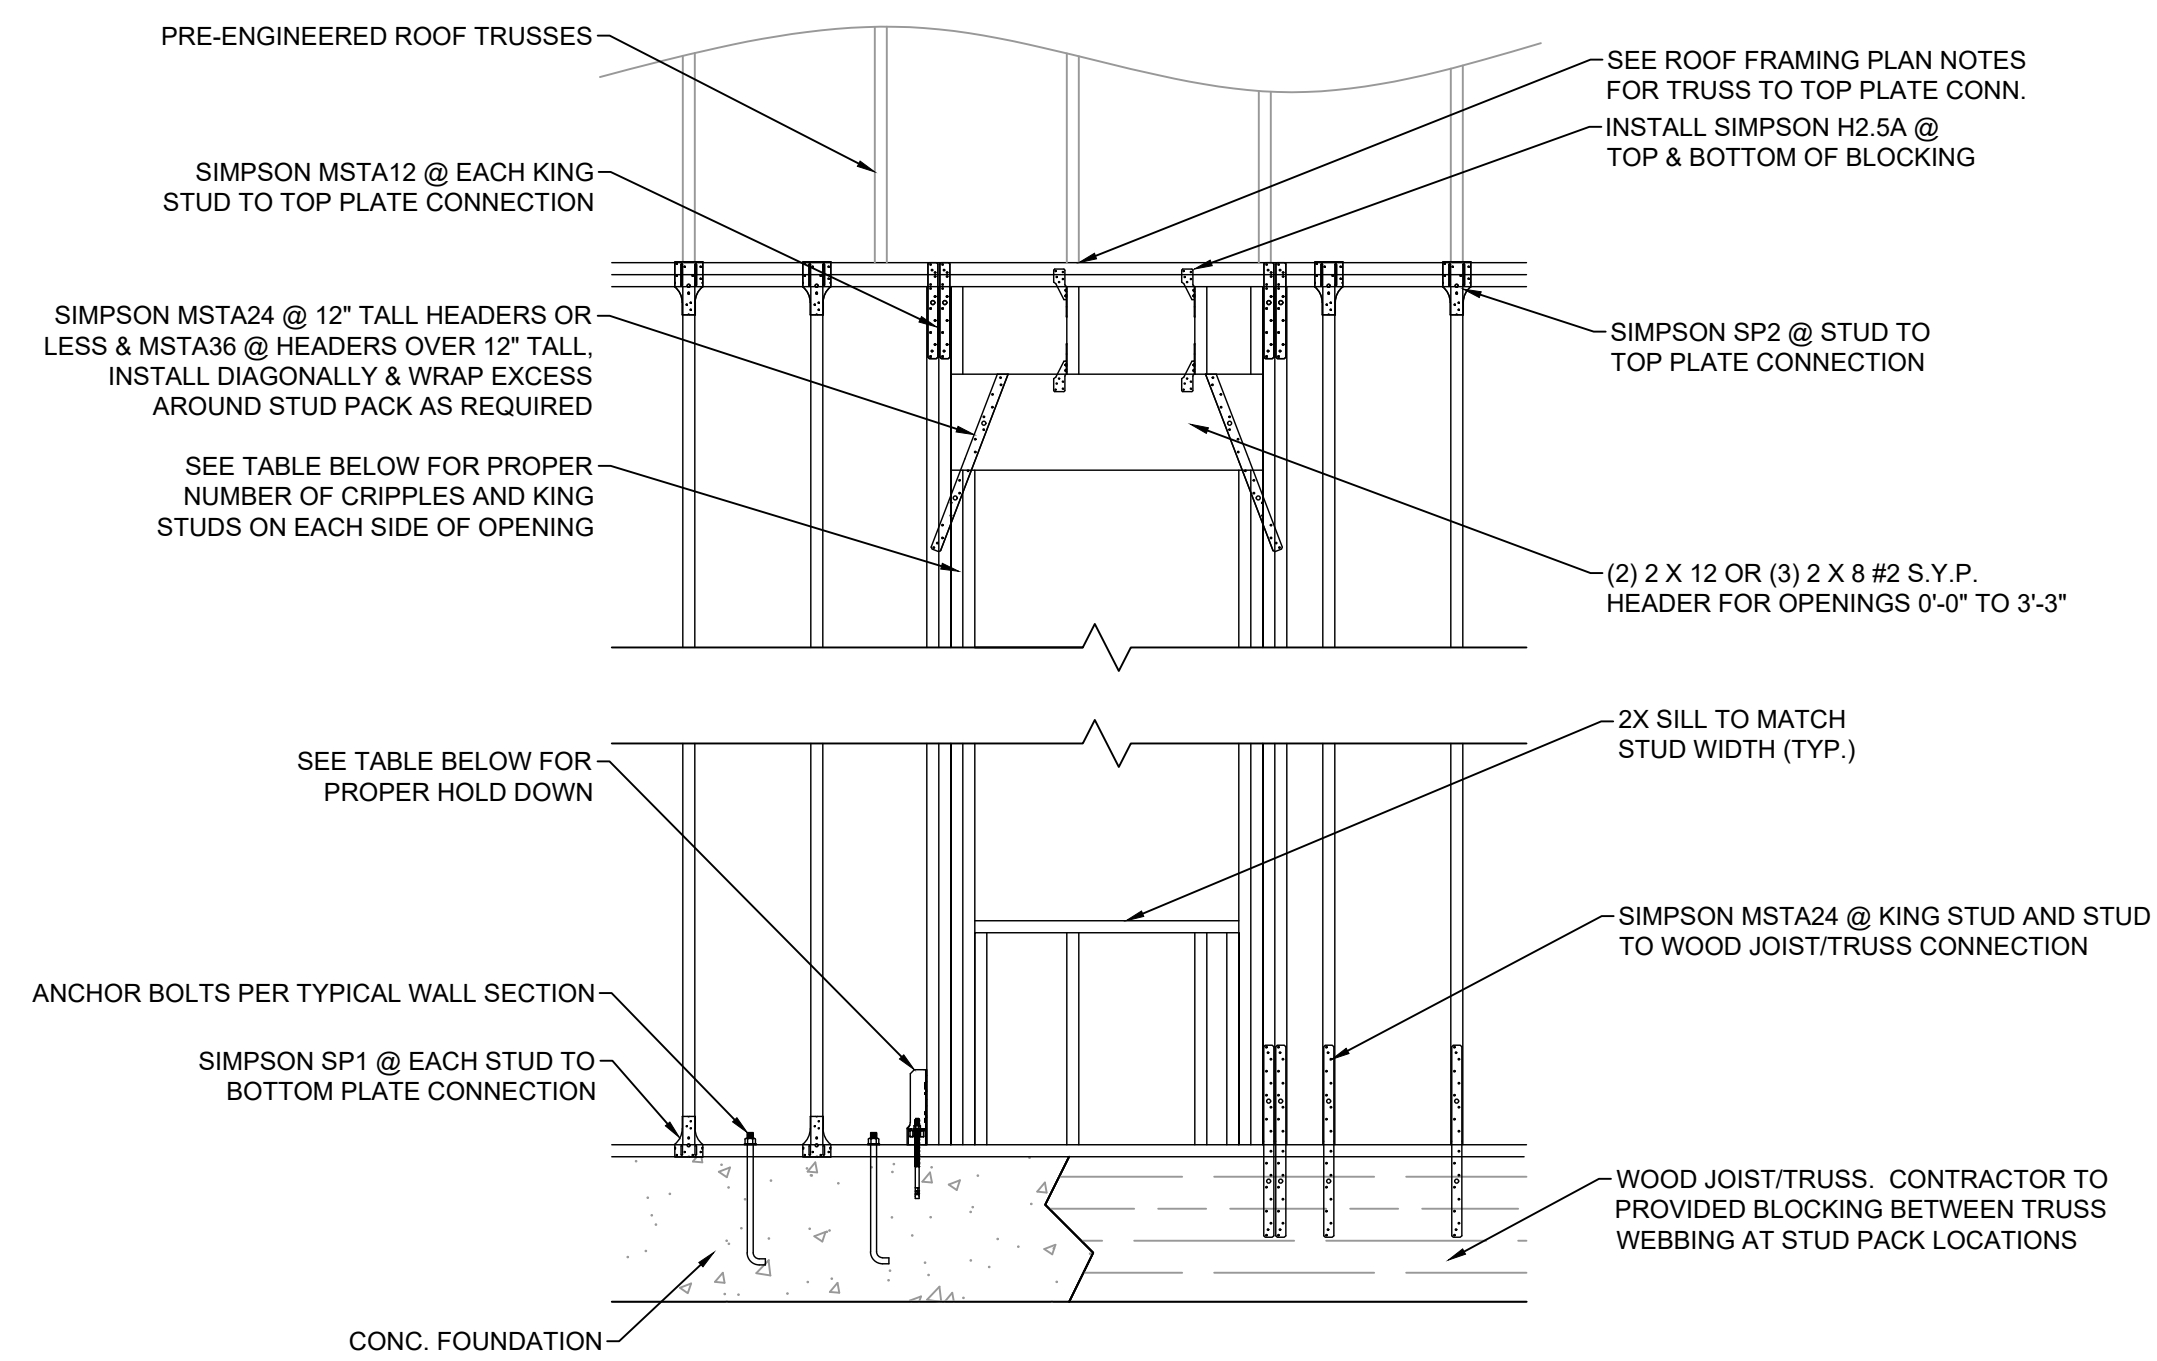

NUMBER OF CRIPPLES & KING STUDS			HOLD DOWNS @ CONC. FOOTING	
OPENING SIZE	# CRIPPLES	# KING STUDS	OPENING SIZE	HOLD DOWN
0'-0" TO 3'-0"	2	2	0'-0" TO 3'-3"	N/A
3'-1" TO 6'-0"	2	2		
6'-1" TO 9'-0"	3	3		
9'-1" TO 12'-0"	4	4		

**4**  
**S2** TYPICAL WALL OPENING DETAIL  
SCALE: N.T.S.

